XCHANGE MEDICAL



	INDEX OF SHEETS
No	Title
00 TITLE	
00-TITLE T001	TITLE SHEET
01-CIVIL	TITLE SHEET
C1-1	DEMOLITION PLAN
C2-1	SITE PLAN
C3-1	GRADING PLAN
C3-2	STORMWATER POLLUTION PREVENTION PLAN
C3-3	STORMWATER POLLUTION PREVENTION PLAN
C4-1	SANITARY SEWER & WATER MAIN PLAN
C4-2	STORM SEWER PLAN
C8-1	CITY DETAILS
C8-2	CIVIL DETAILS
L1-1	LANDSCAPE PLAN
05-PRELIMIN	
A200-P	FLOOR PLAN - LOWER LEVEL
A201-P	FLOOR PLAN - LEVEL 01
A202-P	FLOOR PLAN - LEVEL 02
A203-P	FLOOR PLAN - LEVEL 03
A210-P	ROOF PLAN
A300-P	ELEVATIONS
A301-P	ELEVATIONS
A900-P	BUILDING RENDERING
A901-P	BUILDING RENDERING
A902-P	BUILDING RENDERING
A903-P	BUILDING RENDERING
A904-P	BUILDING RENDERING
A905-P	BUILDING RENDERING
SL-1	SITE LIGHTING PLAN
SL-2	SITE LIGHTING PLAN- NIGHT

PROJECT CONTACT LIST

BUILDING OWNER

MINNEAPOLIS, MN

DAVIS HEALTHCARE REAL ESTATE SERVICES MARK DAVIS 33 SOUTH 6TH STREET **SUITE 4650**

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TIMCO CONSTRUCTION

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PLYMOUTH, MN

TIM MCKEE TMCKEE@TIMCO-CONST.COM 763 . 694 . 0250

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PATRICK J GIORDANA

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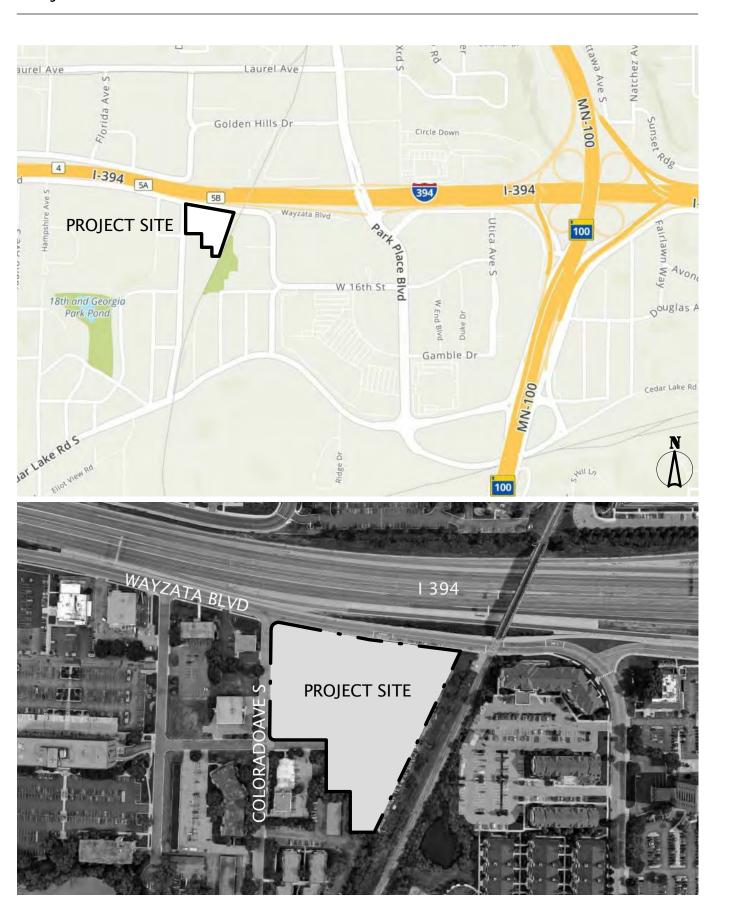
STRUCTURAL ENGINEER


KOMA, INC MATT VAN HOOF 6115 CAHILL AVE MVANHOOF@KOMAINC.COM INVER GROVE HEIGHTS, MN 651 . 789 . 4129

LANDSCAPE ARCHITECT

DOUG LOKEN, LA DLOKEN@LOUCKSINC.COM LOUKS, INC 7200 HEMLOCK LANE MAPLE GROVE, MN

PROJECT LOCATION MAP



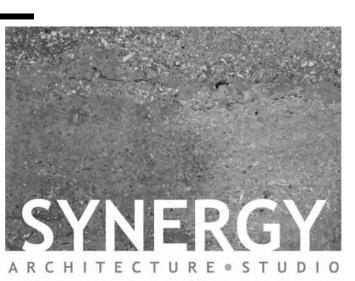

33 SOUTH 6TH STREET MINNEAPOLIS, MN 55402

612.383.2701 | SYNERGYARCHSTUDIO.COM

DAVIS HEALTHCARE REAL ESTATE 33 SOUTH 6TH STREET SUITE 4650 MINNEAPOLIS, MN 55402 612 . 338 . 4000 | DAVISHRE.COM

XCHANGE **MEDICAL**

394 AND WAYZATA BLVD

I HEREBY CERTIFY THAT THIS PLAN, SPECIFICATION, OR REPORT WAS PREPARED BY ME OR UNDER MY DIRECT SUPERVISION AND THAT I AM A DULY LICENSED ARCHITECT


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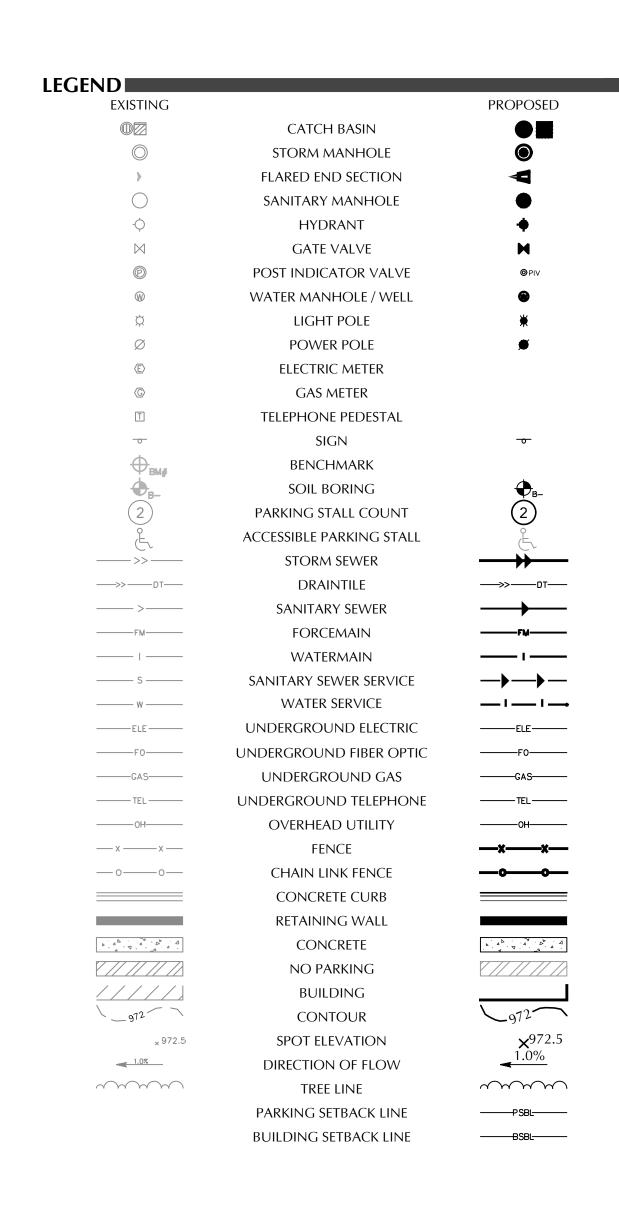
MINNESOTA

Patrick J Giordana 06.01.2020

Project No Drawn By EM / DB / MWO Description 06.01.2020 CITY SUBMITTAL CITY SUBMITTAL 06.24.2020 07.21.2020 CITY SUBMITTAL CITY SUBMITTAL 07.24.2020

TITLE SHEET



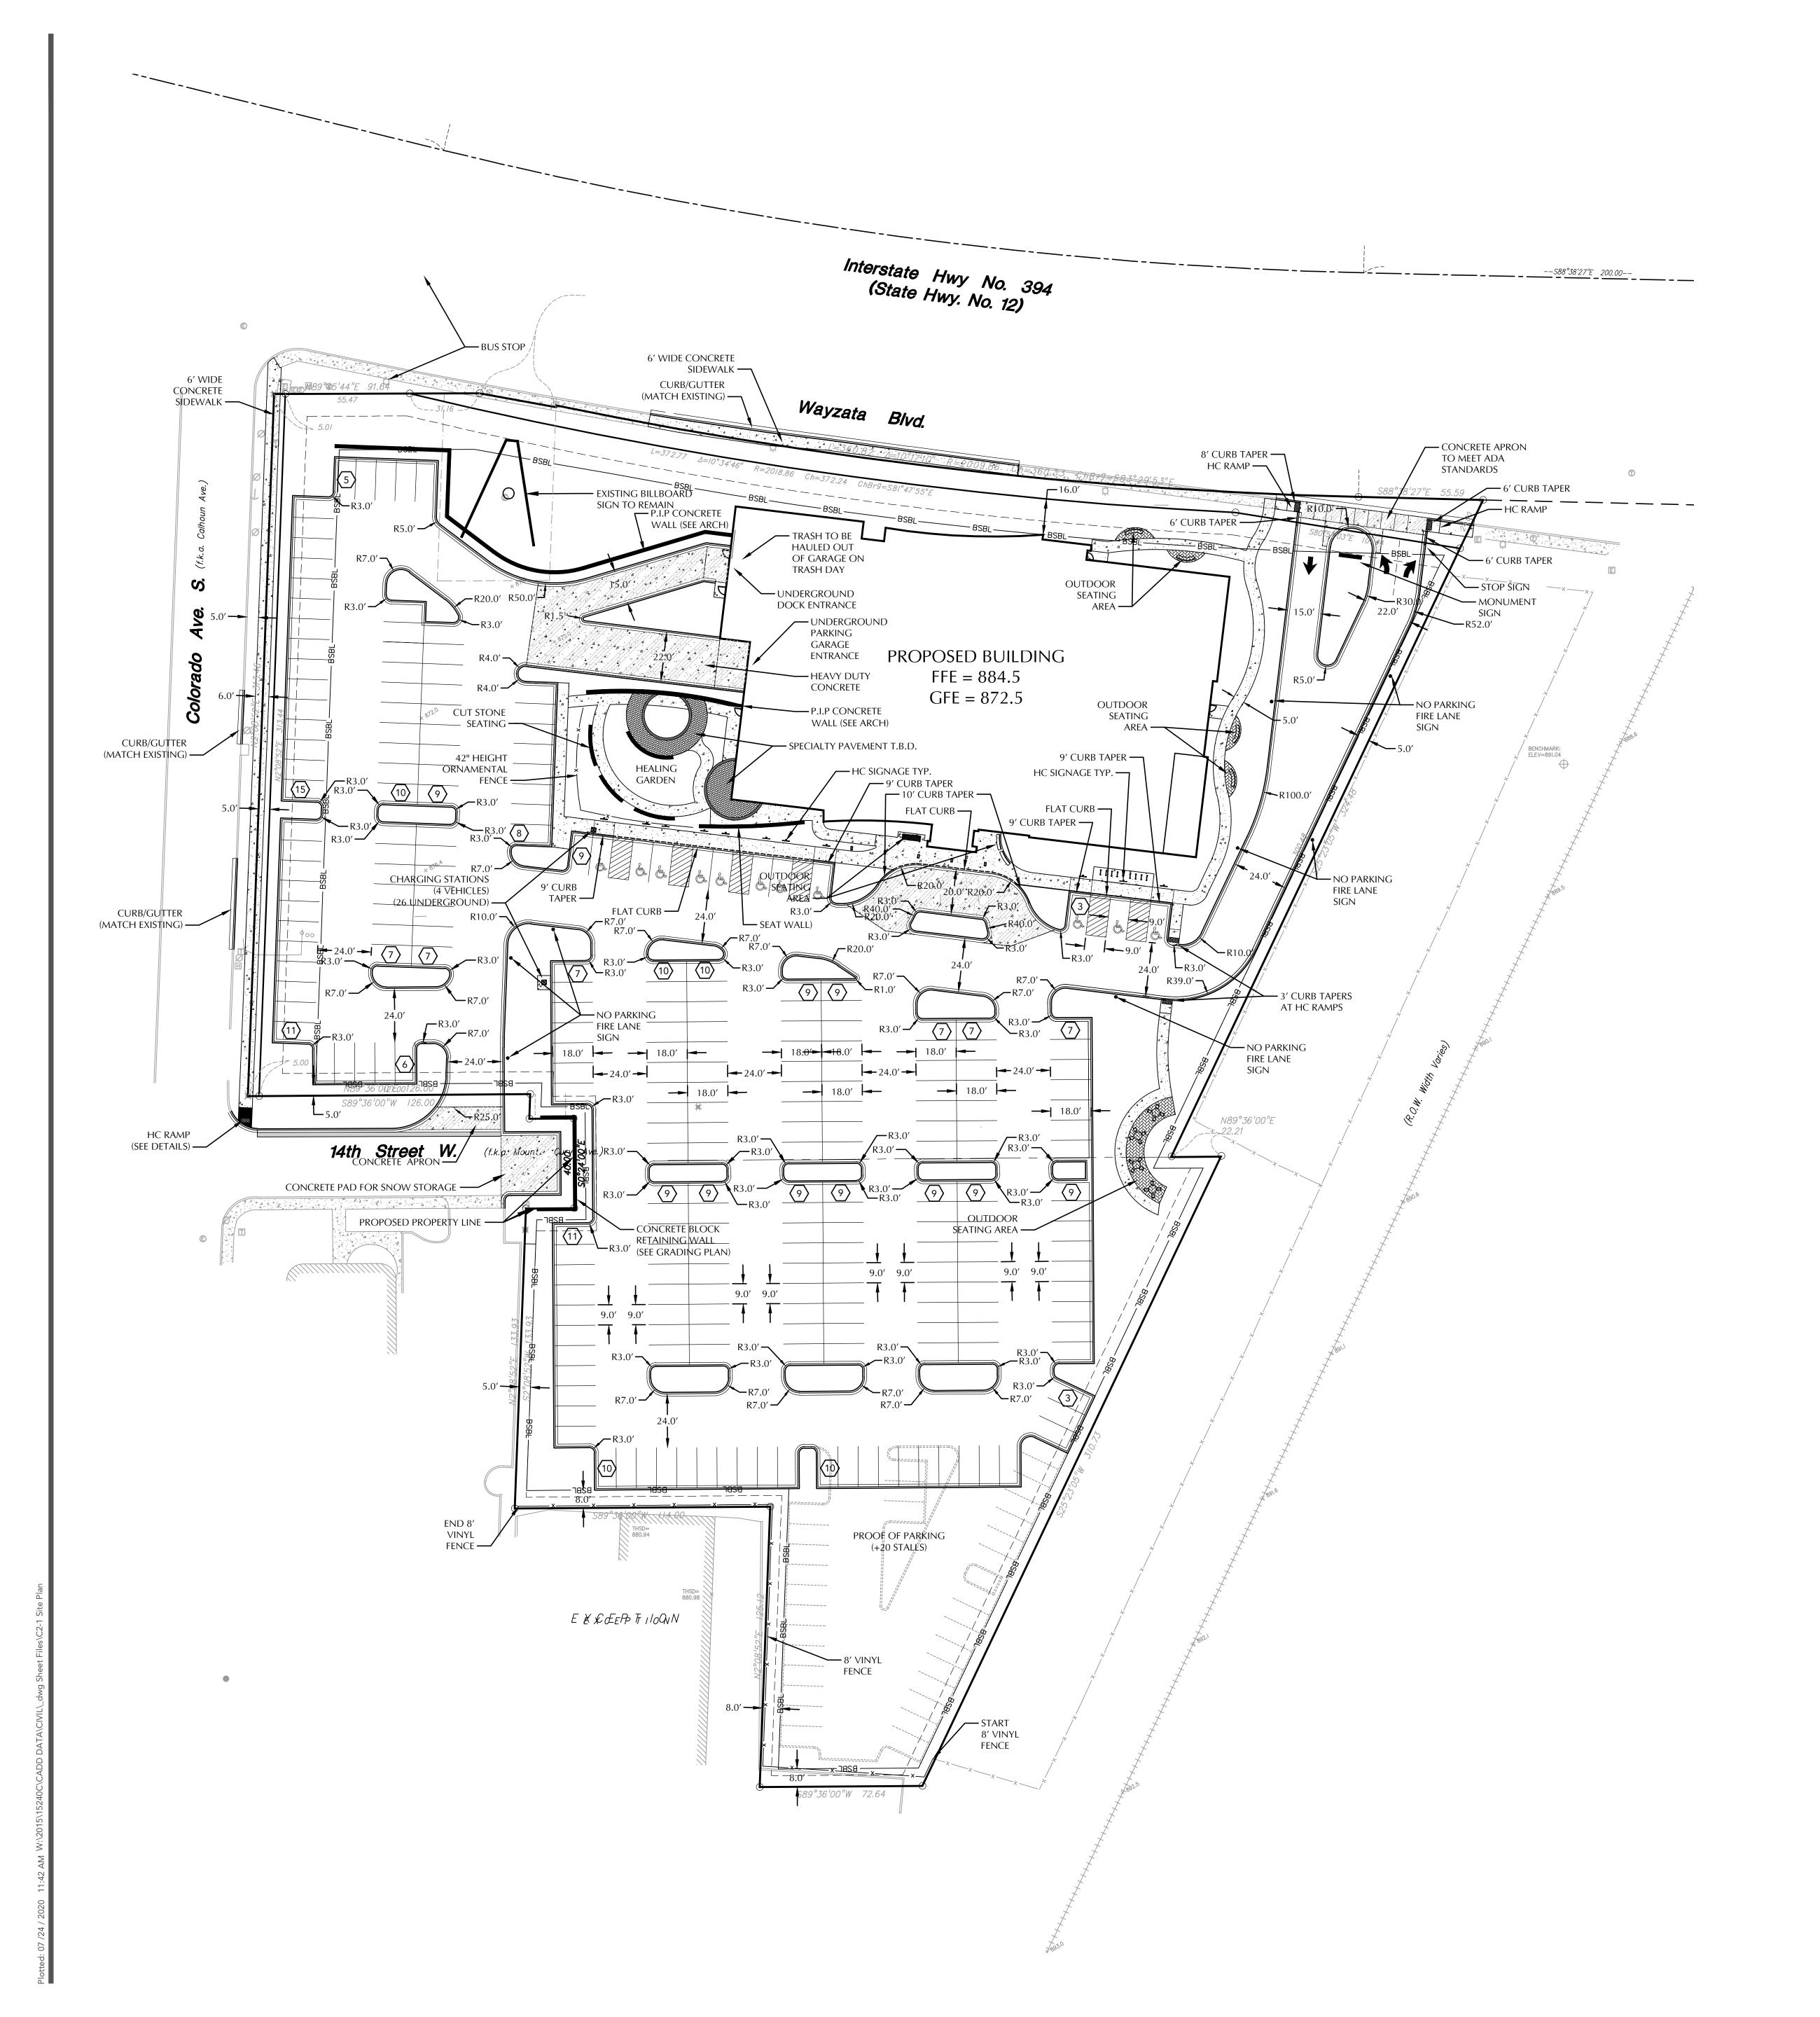





CIVIL ENGINEERING LAND SURVEYING LANDSCAPE ARCHITECTURE ENVIRONMENTAL 7200 Hemlock Lane, Suite 300 Maple Grove, MN 55369 763.424.5505 www.loucksinc.com

	CADD QUALIFICATION	
PAVEMENT LEGEND	CADD files prepared by the Consultant for this project are instruments of the Consultant professional services for use solely with respect to this project. These CADD files shall not be used on other projects, for additions to this project, or for completion of this project by others without written approval by the	
DENOTES LIGHT DUTY BITUMINOUS PAVEMENT	Consultant. With the Consultant's approval, others may be permitted to obtain copies of the CADD drawing files for	
DENOTES HEAVY DUTY BITUMINOUS PAVEMENT	information and reference only. All intentional or unintentional revisions, additions, or deletions to these CADD files shall be made at the full risk of that party making such revisions, additions or deletions and that party shall hold harmless and indemnify the	
DENOTES CONCRETE PAVEMENT	Consultant from any & all responsibilities, claims, and liabilities.	
DENOTES HEAVY DUTY CONCRETE PAVEMENT	SUBMITTAL/REVISIONS	
	06/01/20 CITY SUBMITTAL	
SITE DATA	06/24/20 CITY SUBMITTAL	
SHE DATA	07/21/20 CITY SUBMITTAL	
CURRENT ZONING: O - OFFICE	07/24/20 CITY SUBMITTAL	
BUILDING SETBACK: 51 FT. FROM COLORADO		
15 FT WAYZATA BLVD		
25.5 SIDE YARD		
PROPERTY AREA: 4.67 AC. (Includes right-of-way dedicated to the city)		
EXISTING IMPERVIOUS AREA: 3.10 AC. (66.4%)		

FLOOR AREA RATIO 77,500 / 196,409 = 39.5%

PROPOSED IMPERVIOUS AREA: 3.38 AC. (72.4%)

GROUND FLOOR AREA RATIO 27,871 / 196,409 = 14.2%

SITE NOTES

- 1. ALL PAVING, CONCRETE CURB, GUTTER AND SIDEWALK SHALL BE FURNISHED AND INSTALLED IN ACCORDANCE WITH THE DETAILS SHOWN PER THE DETAIL SHEET(S) AND STATE/LOCAL JURISDICTION REQUIREMENTS.
- 2. ACCESSIBLE PARKING AND ACCESSIBLE ROUTES SHALL BE PROVIDED PER CURRENT ADA STANDARDS AND LOCAL/STATE REQUIREMENTS.
- 3. ALL CURB DIMENSIONS SHOWN ARE TO THE FACE OF CURB UNLESS OTHERWISE NOTED.
- 5. TYPICAL FULL SIZED PARKING STALL IS 9' X 18' WITH A 24' WIDE TWO WAY DRIVE OR 9'X18' WITH CURB OVERHANG

4. ALL BUILDING DIMENSIONS ARE TO THE OUTSIDE FACE OF WALL UNLESS OTHERWISE NOTED.

- 6. ALL CURB RADII SHALL BE 3.0' UNLESS OTHERWISE NOTED.
- 7. BITUMINOUS IMPREGNATED FIBER BOARD TO BE PLACED AT FULL DEPTH OF CONCRETE ADJACENT TO EXISTING STRUCTURES AND BEHIND CURB ADJACENT TO DRIVEWAYS AND SIDEWALKS.
- 8. SEE SITE ELECTRICAL PLAN FOR SITE LIGHTING.
- 9. ALL SIGN POSTS TO BE 2.25" Ø ALUMINUM POSTS.

OFF-STREET PARKING CALCULATIONS

CITY PARKING REQUIREMENT: ONE STALLS PER 200 SF MINUS 10% REDUCTION ON TRANSIT LINE


REQUIRED STALLS = $77,500 \text{ SF} / 200 \times 90\% = 349 \text{ STALLS}$ PROPOSED SURFACE STALLS = 253 PROPOSED GARAGE STALLS = 51

TOTAL STALLS = PROOF OF PARKING =

ACCESSIBLE PARKING ■ PROPOSED ACCESSIBLE SURFACE PARKING: 11 STALLS

REQUIRED ACCESSIBLE PARKING: 8 STALLS**

**REQUIRED MINIMUM NUMBER OF ACCESSIBLE SPACES FOR 301 TO 400 STALLS

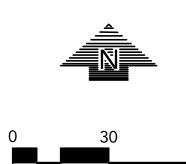



WARNING: THE CONTRACTOR SHALL BE RESPONSIBLE FOR CALLING FOR LOCATIONS OF ALL EXISTING UTILITIES. THEY SHALL COOPERATE WITH ALL UTILITY COMPANIES IN

MAINTAINING THEIR SERVICE AND / OR RELOCATION OF LINES. THE CONTRACTOR SHALL CONTACT GOPHER STATE ONE CALL AT 651-454-0002 AT LEAST 48 HOURS IN ADVANCE FOR THE LOCATIONS OF ALL UNDERGROUND WIRES, CABLES, CONDUITS, PIPES, MANHOLES, VALVES OR OTHER BURIED STRUCTURES BEFORE DIGGING. THE CONTRACTOR SHALL REPAIR OR REPLACE THE ABOVE WHEN DAMAGED DURING CONSTRUCTION AT NO COST TO THE OWNER.

SITE PLAN

PROFESSIONAL SIGNATURE

QUALITY CONTROL

DEMOLITION PLAN

JITARY & WATERMAIN

15240.0C

07/24/20

SITE PLAN

GRADING PLAN

SWPPP NOTES

STORM SEWER

CITY DETAILS

CIVIL DETAILS

LANDSCAPE PLAN

PJD

DDL

PJD

I hereby certify that this plan, specification or report was

prepared by me or under my direct supervision and that I am a duly Licensed Professional Engineer under the

laws of the State of Minnesota.

License No.

Loucks Project No

Project Lead

Checked By


Review Date

C8-1

C8-2

L1-1

Drawn By

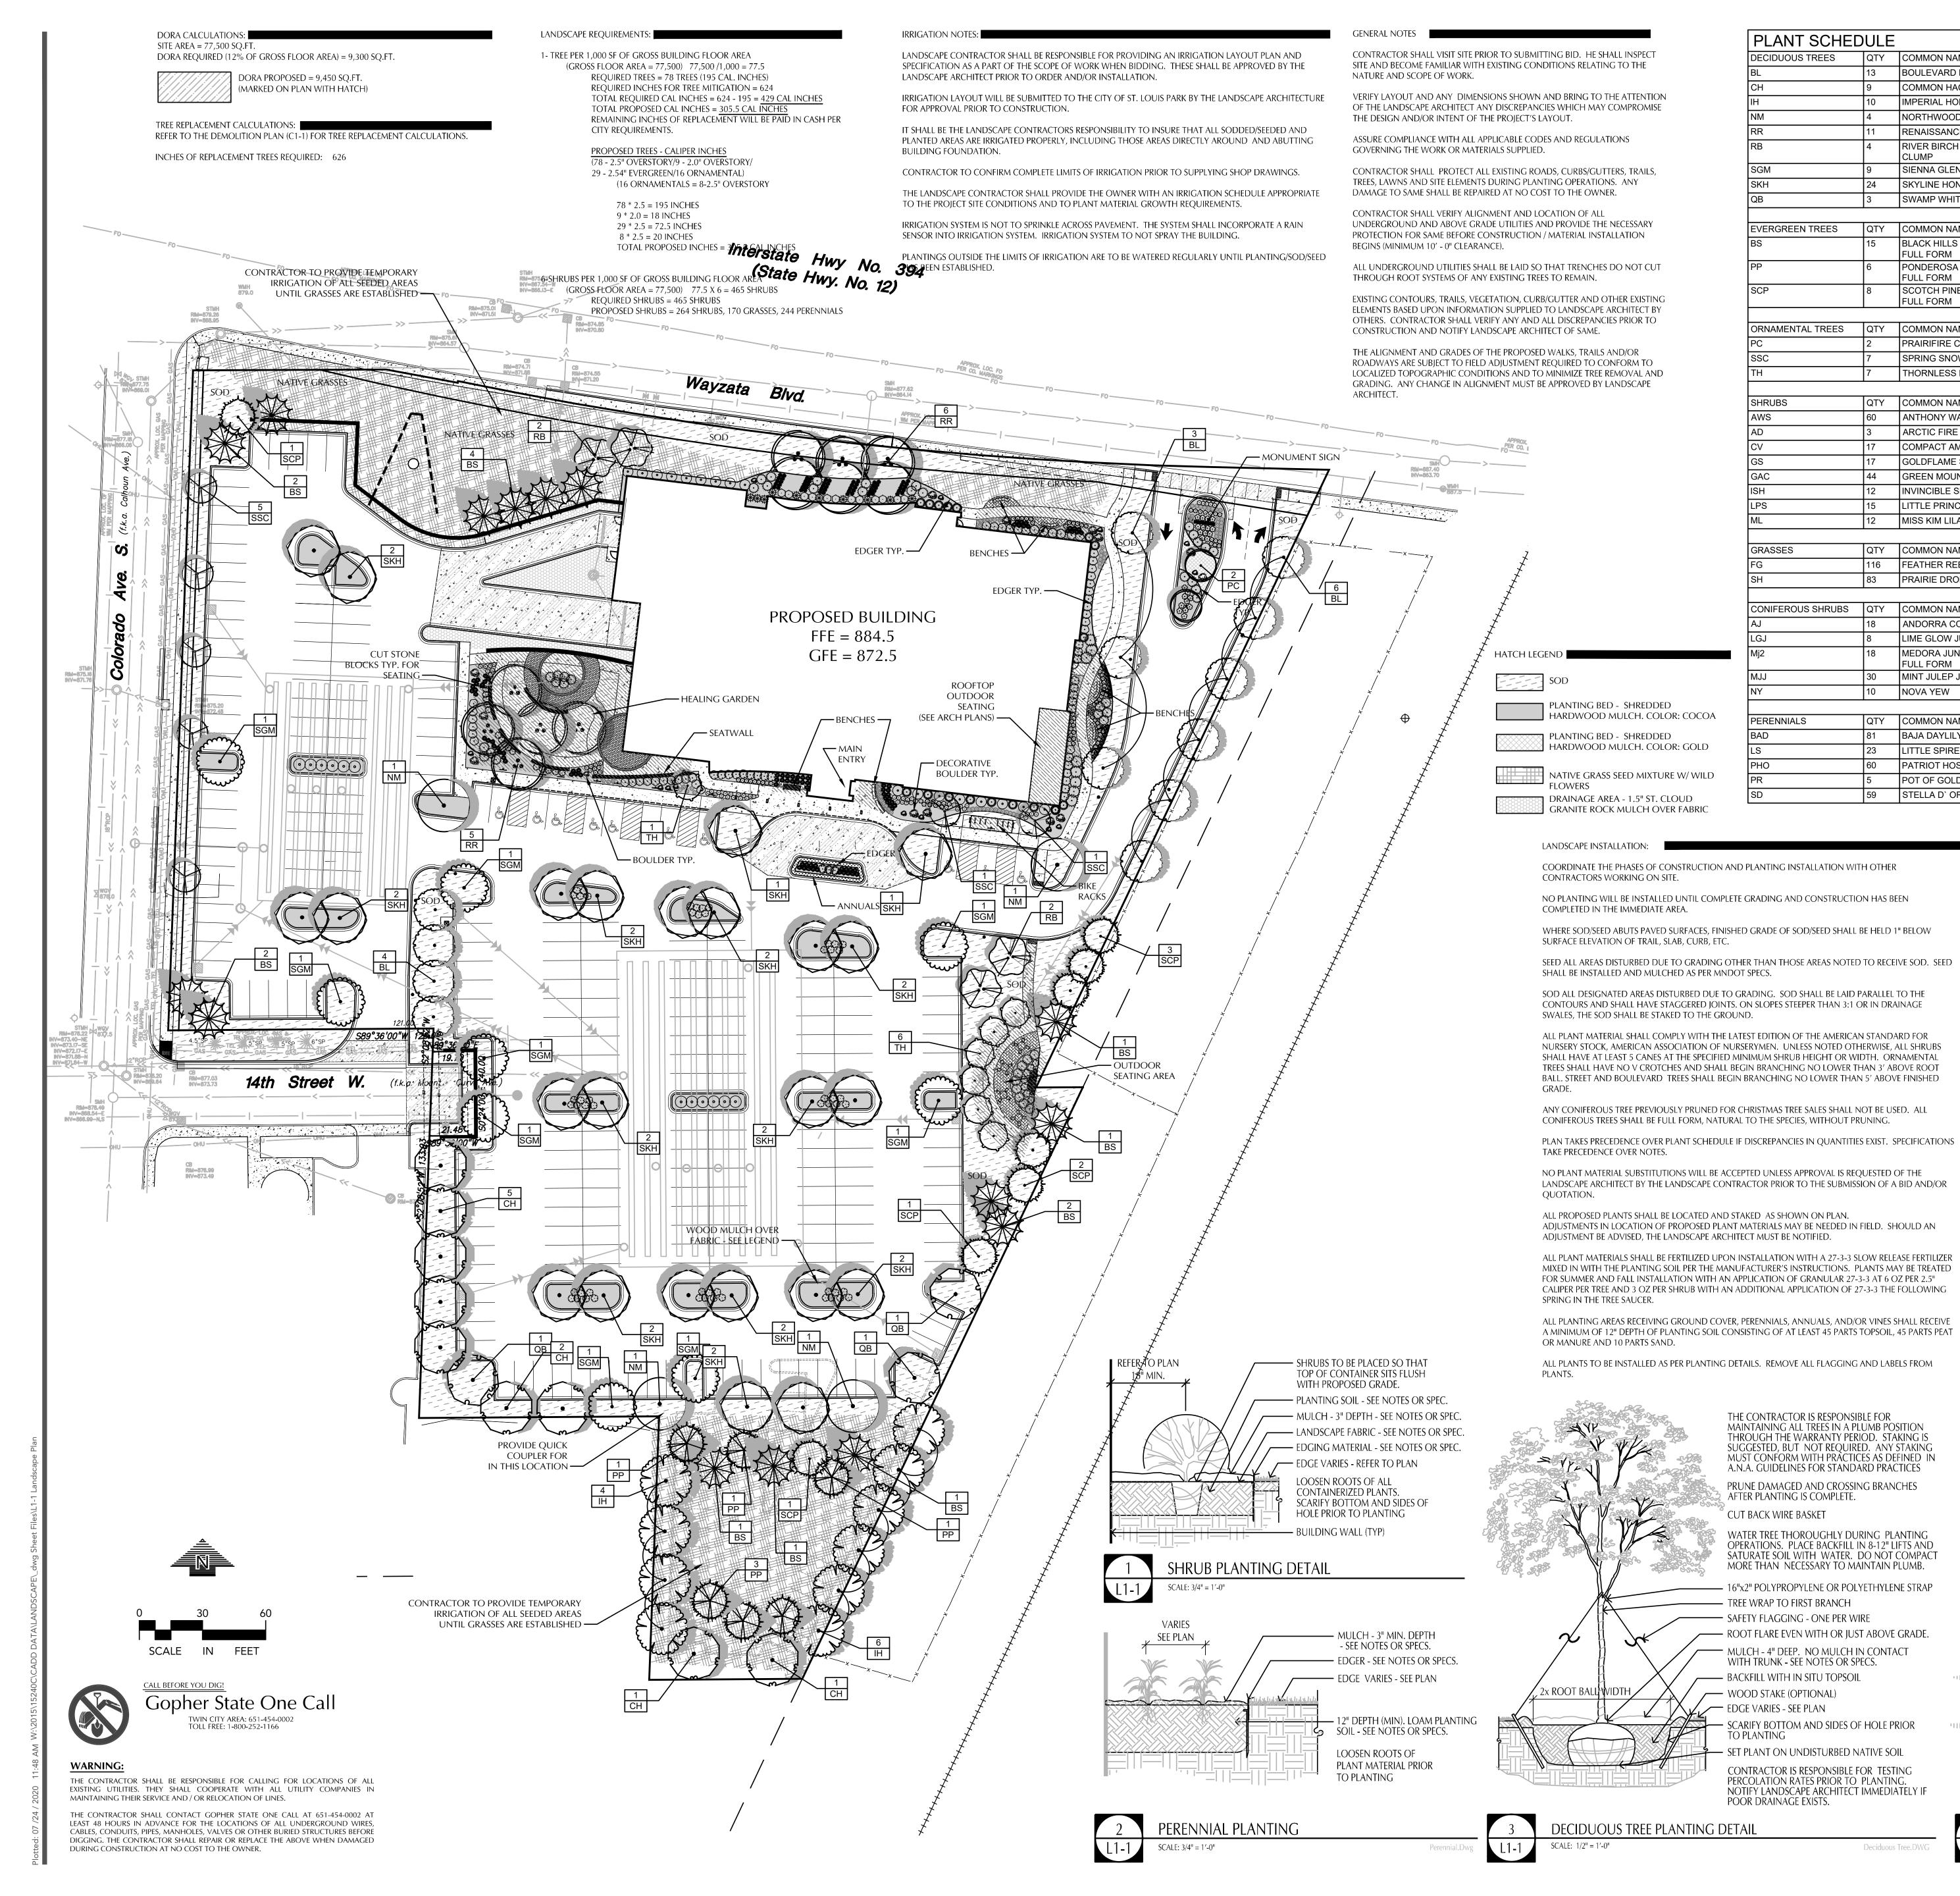

PLANT SCHEDULE DECIDUOUS TREES QTY COMMON NAME BOTANICAL NAME SIZE BOULEVARD LINDEN 2.5"Cal Tilia americana 'Boulevard' OMMON HACKBERRY Celtis occidentalis В&В 2"Cal IMPERIAL HONEYLOCUS Gleditsia triacanthos 'Impcole' TM 2.5"Cal NORTHWOOD MAPLE Acer rubrum 'Northwood' 2.5"Cal B & B RENAISSANCE REFLECTION BIRCH Betula papyrifera 'Renaissance Reflection' B & B 8` HGT B&B 8` HGT Betula nigra IENNA GLEN MAPLE Acer freemanii 'Sienna Glen' 2.5"Cal SKYLINE HONEYLOCUS Gleditsia triacanthos 'Skycole' 2.5"Cal B&B SWAMP WHITE OAK Quercus bicolor B & B 2.5"Cal EVERGREEN TREES QTY COMMON NAME **BOTANICAL NAME** CONT BLACK HILLS SPRUCE Picea glauca `Densata` FULL FORM PONDEROSA PINE B & B Pinus ponderosa **FULL FORM** SCOTCH PINE Pinus sylvestris FULL FORM ORNAMENTAL TREES QTY COMMON NAME BOTANICAL NAME CONT PRAIRIFIRE CRABAPPLE Malus x `Prairifire` B & B 1.5"Cal SPRING SNOW CRABAPPLE Malus x `Spring Snow` B&B 1.5"Cal 1.5"Cal THORNLESS HAWTHORN Crataegus crus-galli `Inermis B & B COMMON NAME BOTANICAL NAME MIN CONT MIN SIZE 24" HGT ANTHONY WATERER SPIREA Spirea x bumalda `Anthony Waterer` Cornus sericea 'Artic Fire' 24" HGT ARCTIC FIRE DOGWOOD 5 gal OMPACT AMERICAN VIBURNUM Viburnum trilobum `Bailey Compact` 24" HGT GOLDFLAME SPIREA Spirea x bumalda 'Goldflame' 24" HGT GREEN MOUND ALPINE CURRANT Ribes alpinum 'Green Mound' 5 gal 24" HGT INVINCIBLE SPIRIT HYDRANGEA Hydrangea arborescens `Invincibelle Spirit` TM ITTLE PRINCESS SPIREA Spirea japonica `Little Princess` 24" HGT Syringa patula `Miss Kim` MISS KIM LILAC 5 gal 24" HGT BOTANICAL NAME **GRASSES** QTY COMMON NAME MIN CONT MIN SIZE 116 FEATHER REED GRASS Calamagrostis x acutiflora `Karl Foerster 1 gal PRAIRIE DROPSEED Sporobolus heterolepis 1 gal CONIFEROUS SHRUBS IQTY COMMON NAME BOTANICAL NAME MIN CONT | MIN SIZE ANDORRA COMPACT JUNIPER Juniperus horizontalis `Plumosa Compacta` 18" SPRD LIME GLOW JUNIPER 18" SPRD Juniperus chinensis 'Lime Glow' |5 gal MEDORA JUNIPER Juniperus scopulorum 'Medora' 15 gal 4` HGT MINT JULEP JUNIPER Juniperus chinensis 'Monlep' 18" SPRD NOVA YEW Taxus cuspidata 'Nova' 18" SPRD 5 gal PERENNIALS COMMON NAME BOTANICAL NAME MIN CONT | MIN SIZE **BAJA DAYLILY** Hemerocallis x 'Baja' ITTLE SPIRE RUSSIAN SAGE Perovskia x `Little Spire` 1 gal PATRIOT HOSTA Hosta x `Patriot` POT OF GOLD RUDBECKIA

> WRAPPING MATERIAL SHALL BE CORRUGATED PVC PIPING 1" GREATER IN CALIPER THAN THE TREE BEING PROTECTED OR QUALITY, HEAVY, WATERPROOF CREPE PAPER MANUFACTURED FOR THIS PURPOSE. WRAP ALL DECIDUOUS TREES PLANTED IN THE FALL PRIOR TO 12-1 AND REMOVE ALL WRAPPING AFTER 5-1.

1 gal

Rudbeckia fulgida `Pot of Gold`

Hemerocallis x `Stella de Oro`

BLACK METAL EDGER TO BE USED TO CONTAIN SHRUBS, PERENNIALS, AND ANNUALS WHERE BED MEETS SOD/SEED UNLESS NOTED OTHERWISE. WHERE SOD/SEED ABUTS PAVED SURFACES, FINISHED GRADE OF SOD/SEED SHALL BE HELD 1" BELOW ALL ANNUAL AND PERENNIAL PLANTING BEDS TO RECEIVE 3" DEEP SHREDDED HARDWOOD MULCH WITH

> NO WEED BARRIER. ALL SHRUB BED MASSINGS TO RECEIVE 3" DEEP SHREDDED HARDWOOD MULCH AND FIBER MAT WEED

> ALL TREES TO RECEIVE 4" DEEP SHREDDED HARDWOOD MULCH WITH NO MULCH IN DIRECT CONTACT WITH TREE TRUNK.

SPREAD GRANULAR PRE EMERGENT HERBICIDE (PREEN OR EQUAL) PER MANUFACTURER'S RECOMMENDATIONS UNDER ALL MULCHED AREAS.

MAINTENANCE STRIPS TO HAVE EDGER AND MULCH AS SPECIFIED/INDICATED ON DRAWING OR IN

SPECIFICATION. IF THE LANDSCAPE CONTRACTOR IS CONCERNED OR PERCEIVES ANY DEFICIENCIES IN THE PLANT SELECTIONS, SOIL CONDITIONS OR ANY OTHER SITE CONDITION WHICH MIGHT NEGATIVELY AFFECT

PLANT ESTABLISHMENT, SURVIVAL OR GUARANTEE, HE MUST BRING THESE DEFICIENCIES TO THE

ATTENTION OF THE LANDSCAPE ARCHITECT PRIOR TO PROCUREMENT AND/OR INSTALLATION. CONTRACTOR SHALL SUBMIT A WRITTEN REQUEST FOR THE OWNER ACCEPTANCE INSPECTION OF ALL LANDSCAPE AND SITE IMPROVEMENTS.

CONTRACTOR IS RESPONSIBLE FOR ON-GOING MAINTENANCE OF ALL NEWLY INSTALLED MATERIALS UNTIL TIME OF OWNER ACCEPTANCE. ANY ACTS OF VANDALISM OR DAMAGE WHICH MAY OCCUR PRIOR TO OWNER ACCEPTANCE SHALL BE THE RESPONSIBILITY OF THE CONTRACTOR. CONTRACTOR SHALL PROVIDE THE OWNER WITH A MAINTENANCE PROGRAM INCLUDING, BUT NOT NECESSARILY LIMITED TO, PRUNING, FERTILIZATION AND DISEASE/PEST CONTROL.


CONTRACTOR SHALL GUARANTEE NEW PLANT MATERIAL THROUGH ONE CALENDAR YEAR FROM THE DATE OF OWNER ACCEPTANCE.

WARRANTY (ONE FULL GROWING SEASON) FOR LANDSCAPE MATERIALS SHALL BEGIN ON THE DATE OF ACCEPTANCE BY THE LANDSCAPE ARCHITECT AFTER THE COMPLETION OF PLANTING OF ALL LANDSCAPE MATERIALS. NO PARTIAL ACCEPTANCE WILL BE CONSIDERED.

UNLESS NOTED OTHERWISE THE APPROPRIATE DATES FOR SPRING PLANT MATERIAL INSTALLATION AND SEED/SOD PLACEMENT IS FROM THE TIME GROUND HAS THAWED TO JUNE 15.

FALL SODDING IS GENERALLY ACCEPTABLE FROM AUGUST 15 - NOVEMBER 1. FALL SEEDING FROM AUGUST 15 - SEPTEMBER 15; DORMANT SEEDING IN THE FALL SHALL NOT OCCUR PRIOR TO NOVEMBER 1. FALL CONIFEROUS PLANTING MAY OCCUR FROM AUGUST 15 - OCTOBER 1 AND DECIDUOUS PLANTING FROM THE FIRST FROST UNTIL NOVEMBER 15. PLANTING OUTSIDE THESE DATES IS NOT RECOMMENDED. ANY ADJUSTMENT MUST BE APPROVED IN WRITING BY THE LANDSCAPE ARCHITECT.

LANDSCAPE CONTRACTOR SHALL ESTABLISH TO HIS SATISFACTION THAT SOIL AND COMPACTION CONDITIONS ARE ADEQUATE TO ALLOW FOR PROPER DRAINAGE AT AND AROUND THE BUILDING SITE.

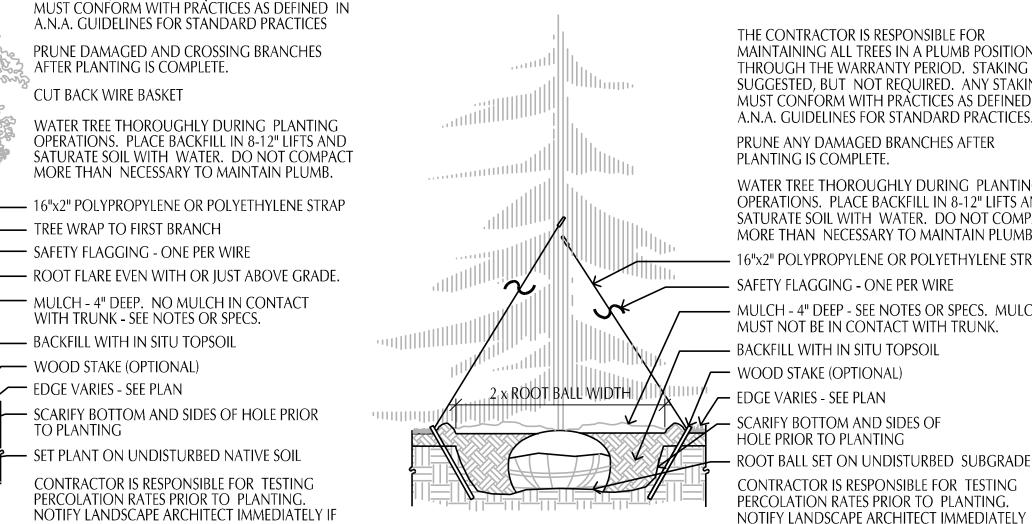

THE CONTRACTOR IS RESPONSIBLE FOR

MAINTAINING ALL TREES IN A PLUMB POSITION

THROUGH THE WARRANTY PERIOD. STAKING IS

SUGGESTED. BUT NOT REOUIRED. ANY STAKING

PRUNE DAMAGED AND CROSSING BRANCHES

AFTER PLANTING IS COMPLETE.

CUT BACK WIRE BASKET

TREE WRAP TO FIRST BRANCH

----- SAFETY FLAGGING - ONE PER WIRE

— BACKFILL WITH IN SITU TOPSOIL

WOOD STAKE (OPTIONAL)

EDGE VARIES - SEE PLAN

POOR DRAINAGE EXISTS.

TO PLANTING

— MULCH - 4" DEEP. NO MULCH IN CONTACT

SCARIFY BOTTOM AND SIDES OF HOLE PRIOR

SET PLANT ON UNDISTURBED NATIVE SOIL

PERCOLATION RATES PRIOR TO PLANTING.

CONTRACTOR IS RESPONSIBLE FOR TESTING

Deciduous Tree.DWG

WITH TRUNK - SEE NOTES OR SPECS.

THE CONTRACTOR IS RESPONSIBLE FOR MAINTAINING ALL TREES IN A PLUMB POSITION THROUGH THE WARRANTY PERIOD. STAKING IS SUGGESTED, BUT NOT REQUIRED. ANY STAKING MUST CONFORM WITH PRACTICES AS DEFINED IN A.N.A. GUIDELINES FOR STANDARD PRACTICES. PRUNE ANY DAMAGED BRANCHES AFTER PLANTING IS COMPLETE.

WATER TREE THOROUGHLY DURING PLANTING OPERATIONS. PLACE BACKFILL IN 8-12" LIFTS AND SATURATE SOIL WITH WATER. DO NOT COMPACT MORE THAN NECESSARY TO MAINTAIN PLUMB. — 16"x2" POLYPROPYLENE OR POLYETHYLENE STRAP — SAFETY FLAGGING - ONE PER WIRE MULCH - 4" DEEP - SEE NOTES OR SPECS. MULCH MUST NOT BE IN CONTACT WITH TRUNK. ——— BACKFILL WITH IN SITU TOPSOIL WOOD STAKE (OPTIONAL)

EDGE VARIES - SEE PLAN SCARIFY BOTTOM AND SIDES OF HOLE PRIOR TO PLANTING ROOT BALL SET ON UNDISTURBED SUBGRADE CONTRACTOR IS RESPONSIBLE FOR TESTING PERCOLATION RATES PRIOR TO PLANTING.

CONIFEROUS TREE PLANTING DETAIL

IF POOR DRAINAGE EXISTS. Coniferous Tree.DWG

ST. LOUIS PARI

CIVIL ENGINEERING LAND SURVEYING LANDSCAPE ARCHITECTURE ENVIRONMENTAL 7200 Hemlock Lane, Suite 300

Maple Grove, MN 55369

www.loucksinc.com

763.424.5505

CADD QUALIFICATION on other projects, for additions to this project, or for completion ormation and reference only. All intentional or unintentional evisions, additions, or deletions to these CADD files shall be nade at the full risk of that party making such revisions, addition Consultant from any & all responsibilities, claims, and liabilities.


SUBMITTAL/REVISIONS CITY SUBMITTAL 06/24/20 CITY SUBMITTAL 07/21/20 CITY SUBMITTAL 07/24/20 CITY SUBMITTAL

PROFESSIONAL SIGNATURE I hereby certify that this plan, specification or report was prepared by me or under my direct supervision and that I am a duly Licensed Landscape Architect under the laws of the State of Minnesota.

License No. 07/24/20 QUALITY CONTROL 15240.0C Loucks Project No PJD Project Lead Drawn By DDL DDL Checked By 07/24/20 Review Date SHEET INDEX


DEMOLITION PLAN SITE PLAN **GRADING PLAN SWPPP NOTES SANITARY & WATERMAIN** STORM SEWER CITY DETAILS CIVIL DETAILS LANDSCAPE PLAN


LANDSCAPE

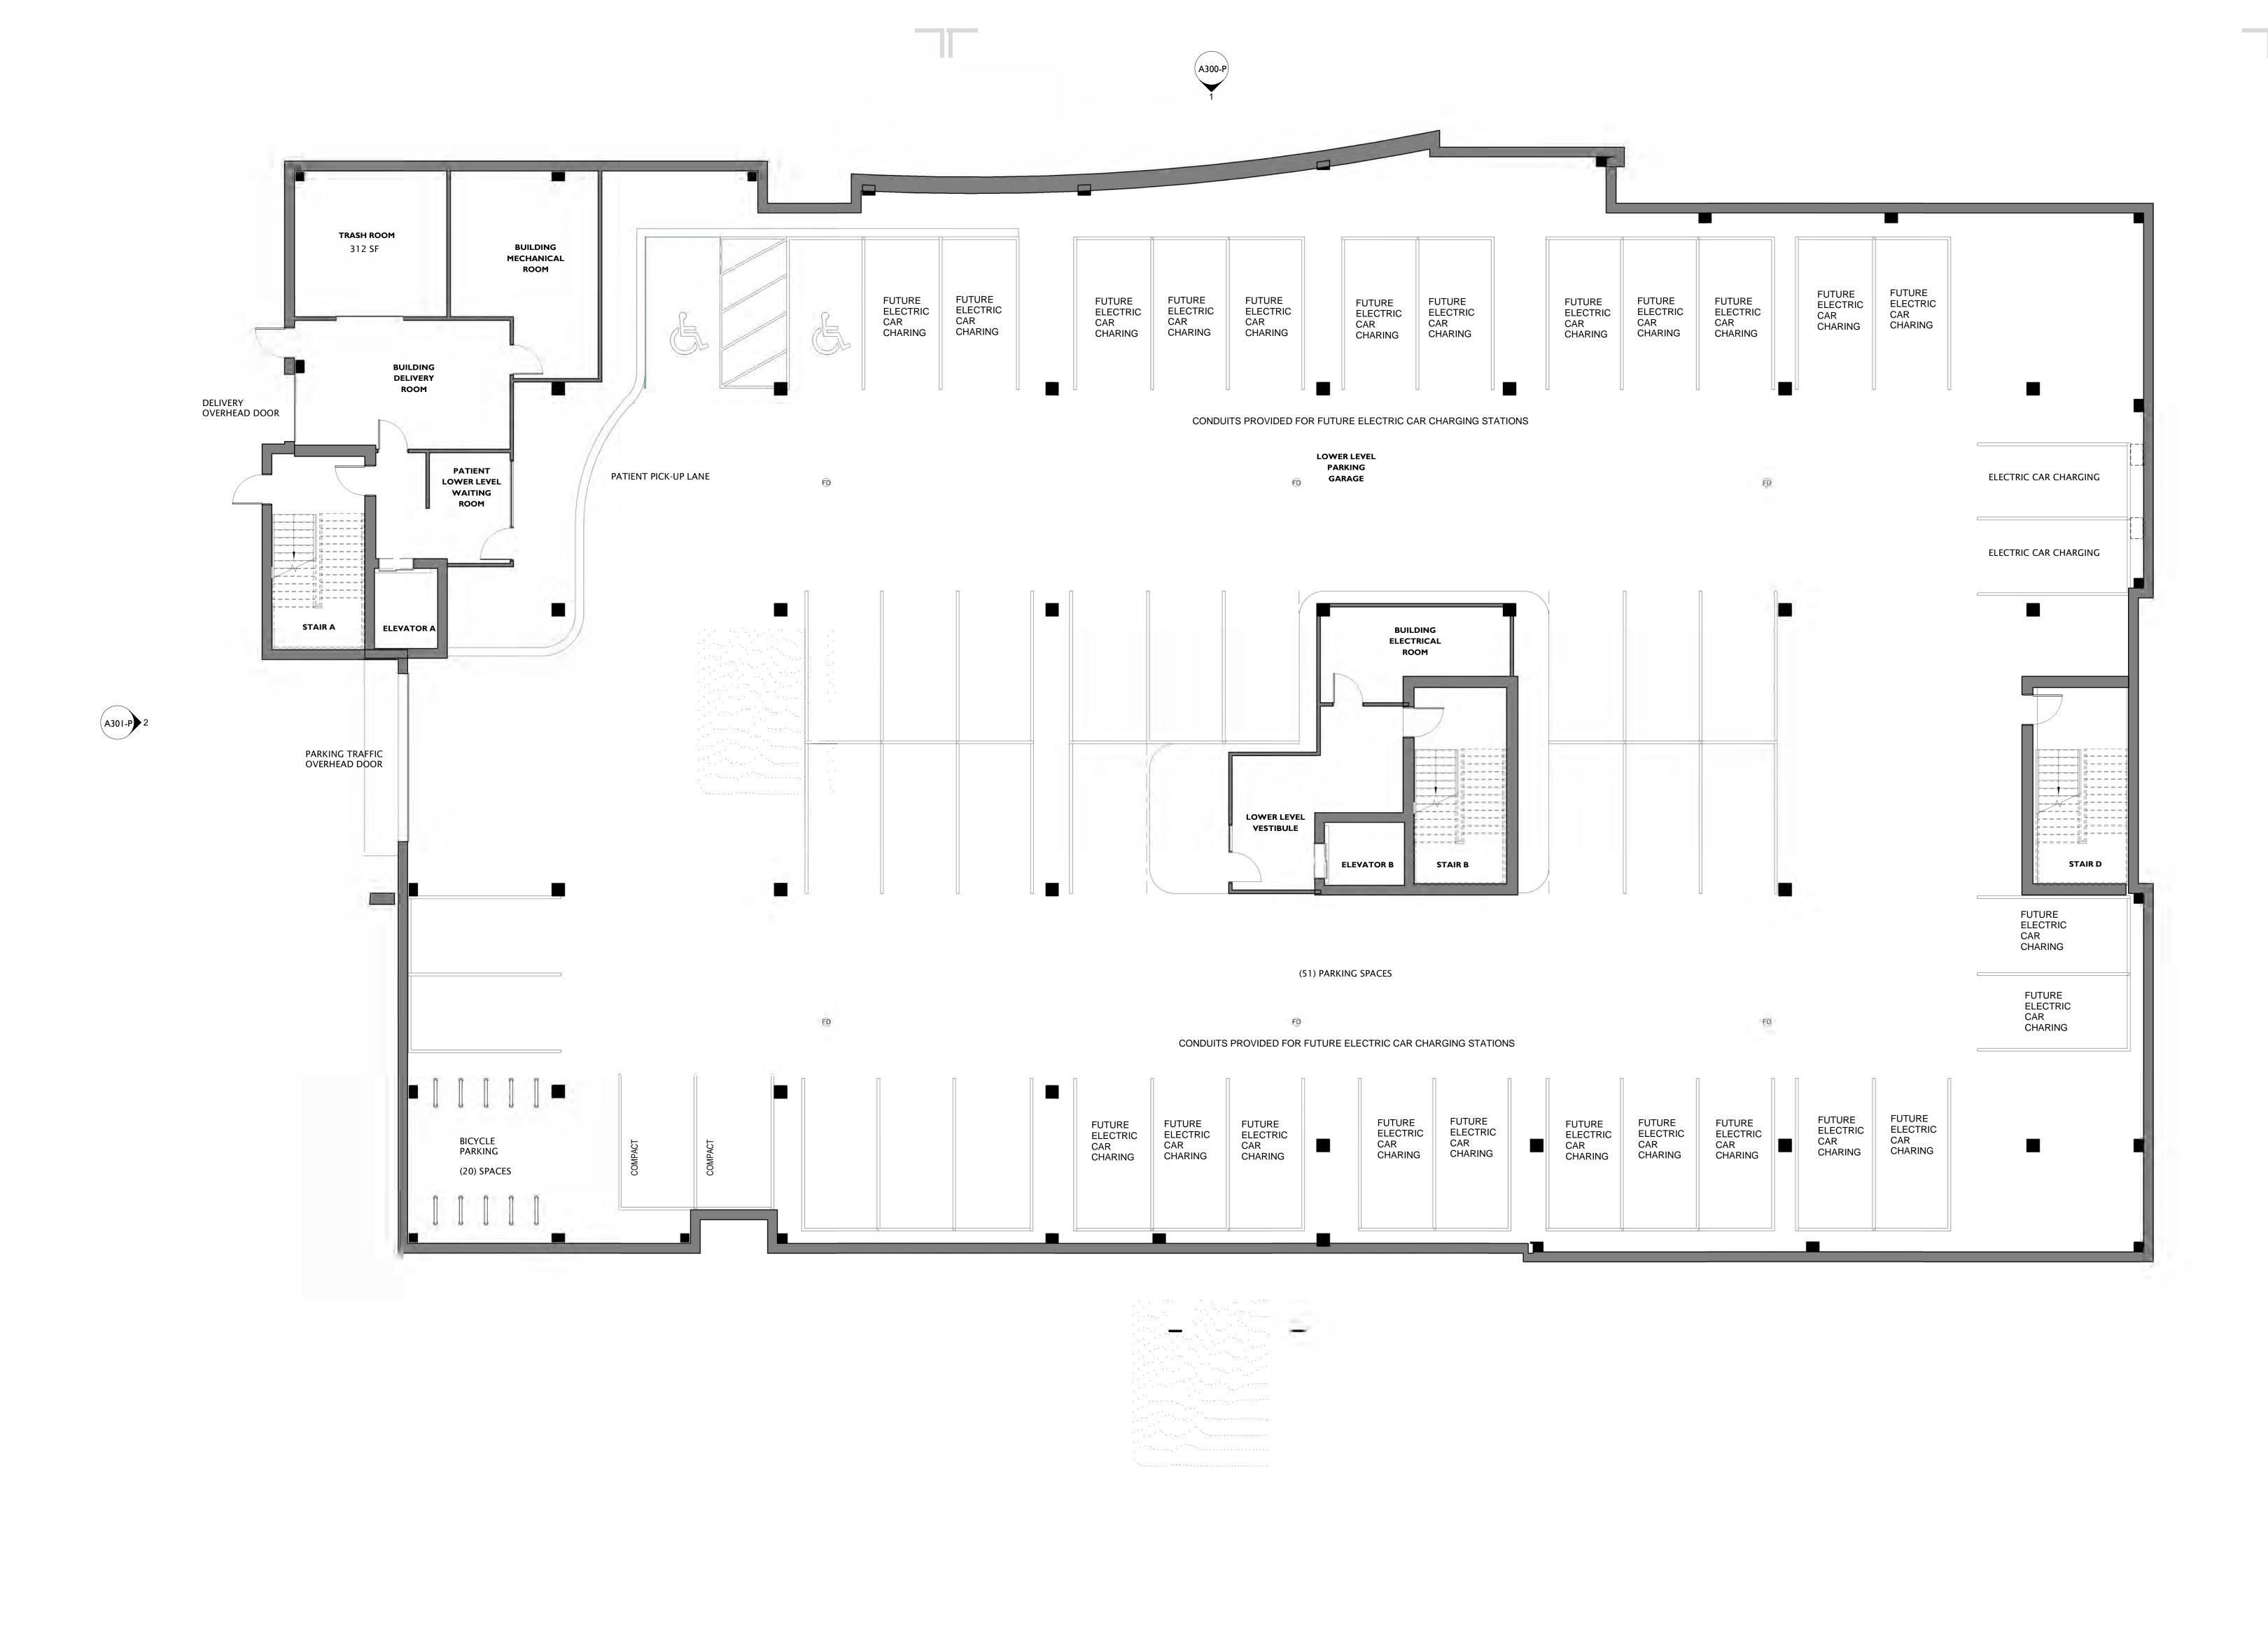







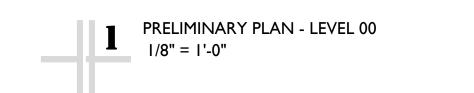

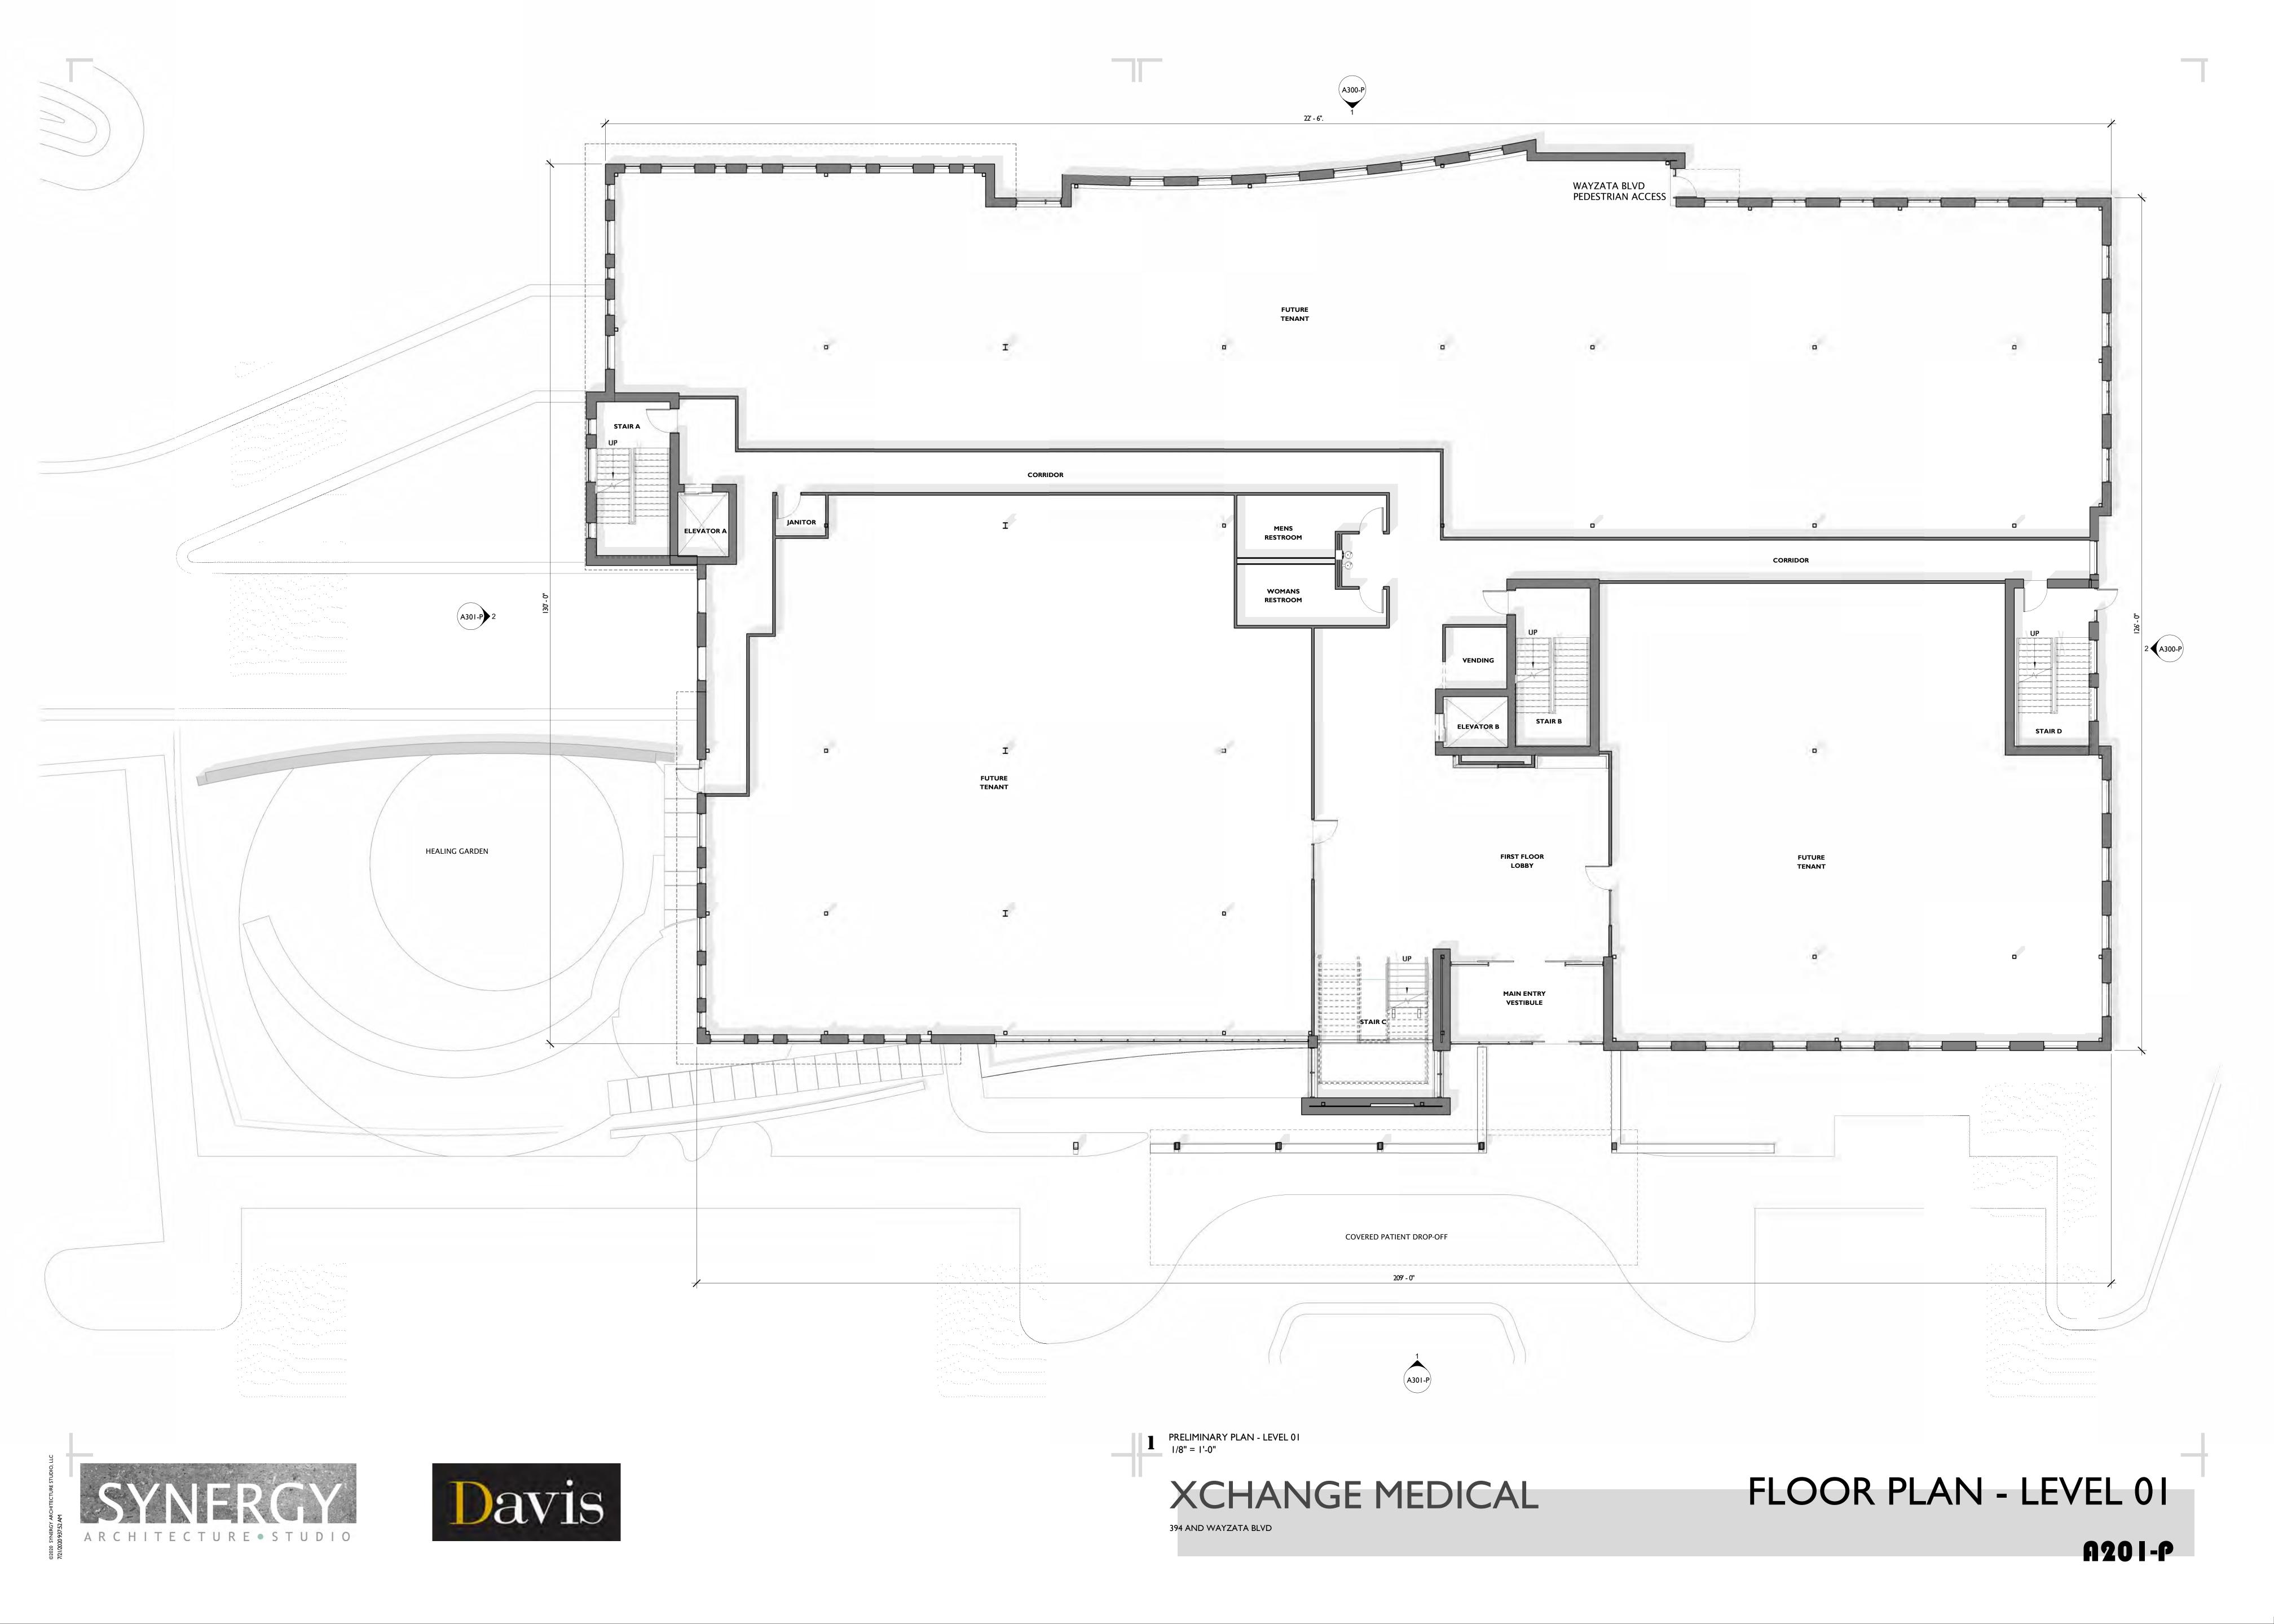

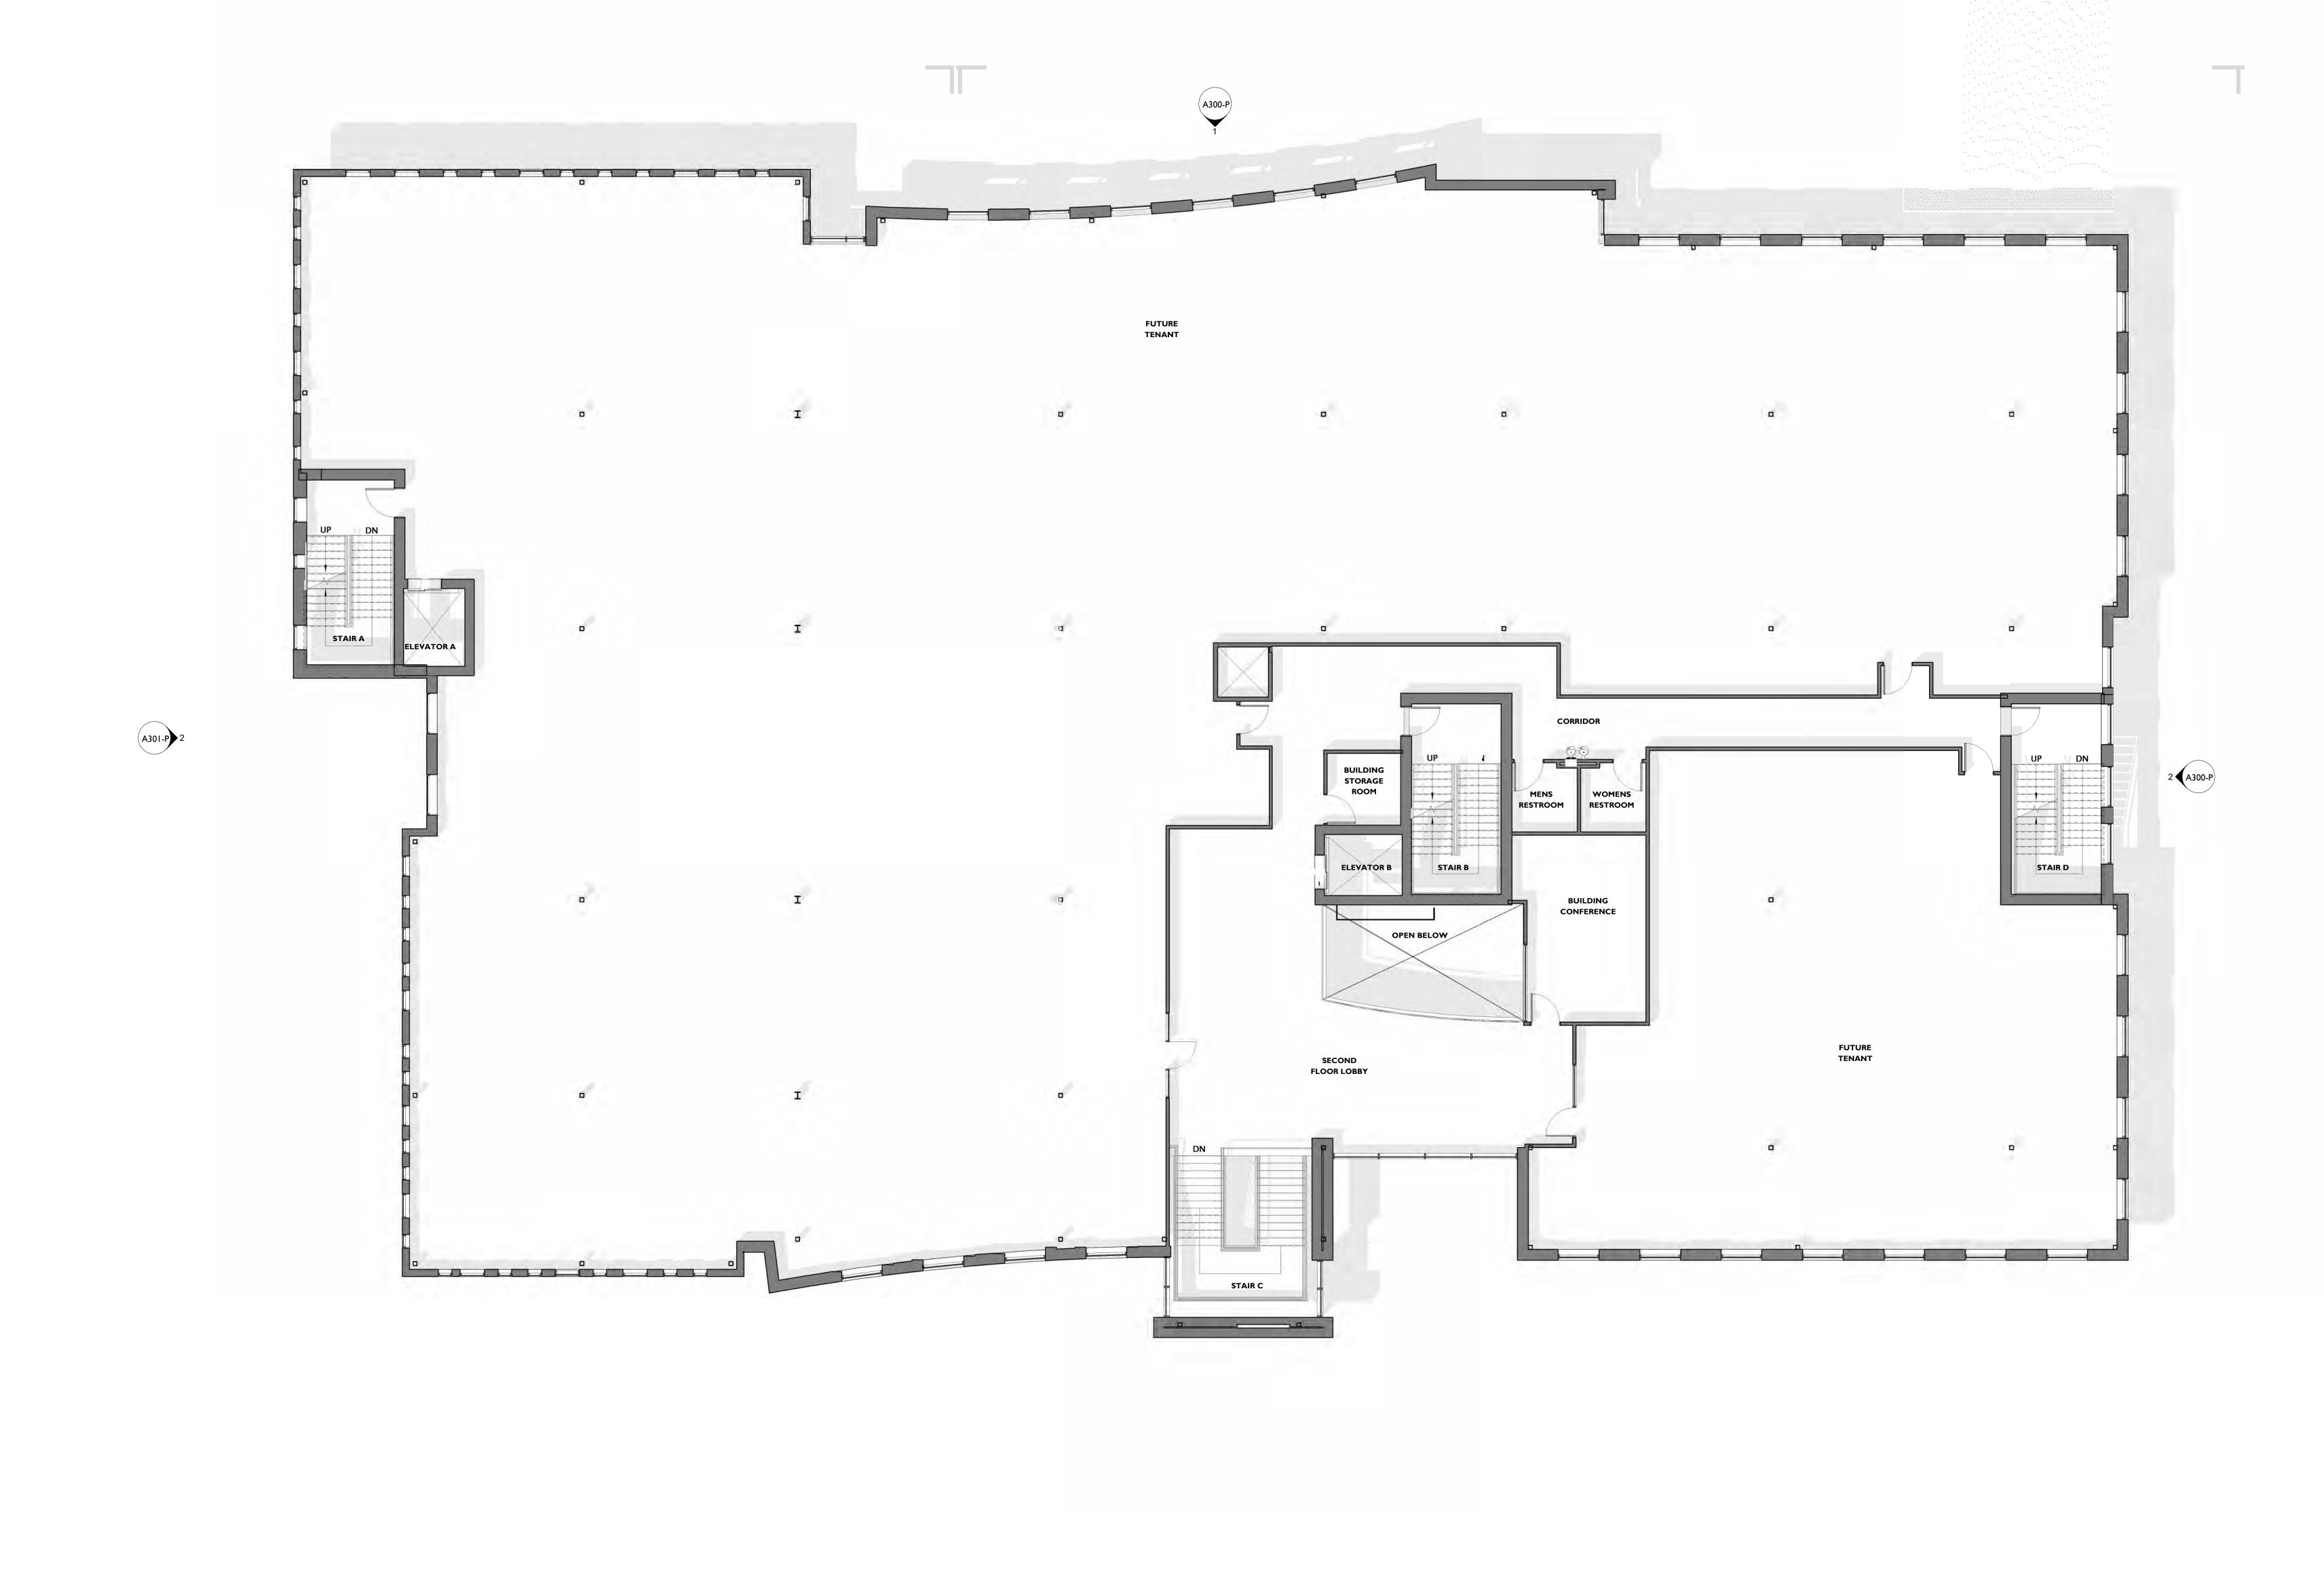

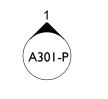









FLOOR PLAN - LEVEL 02

A202-P

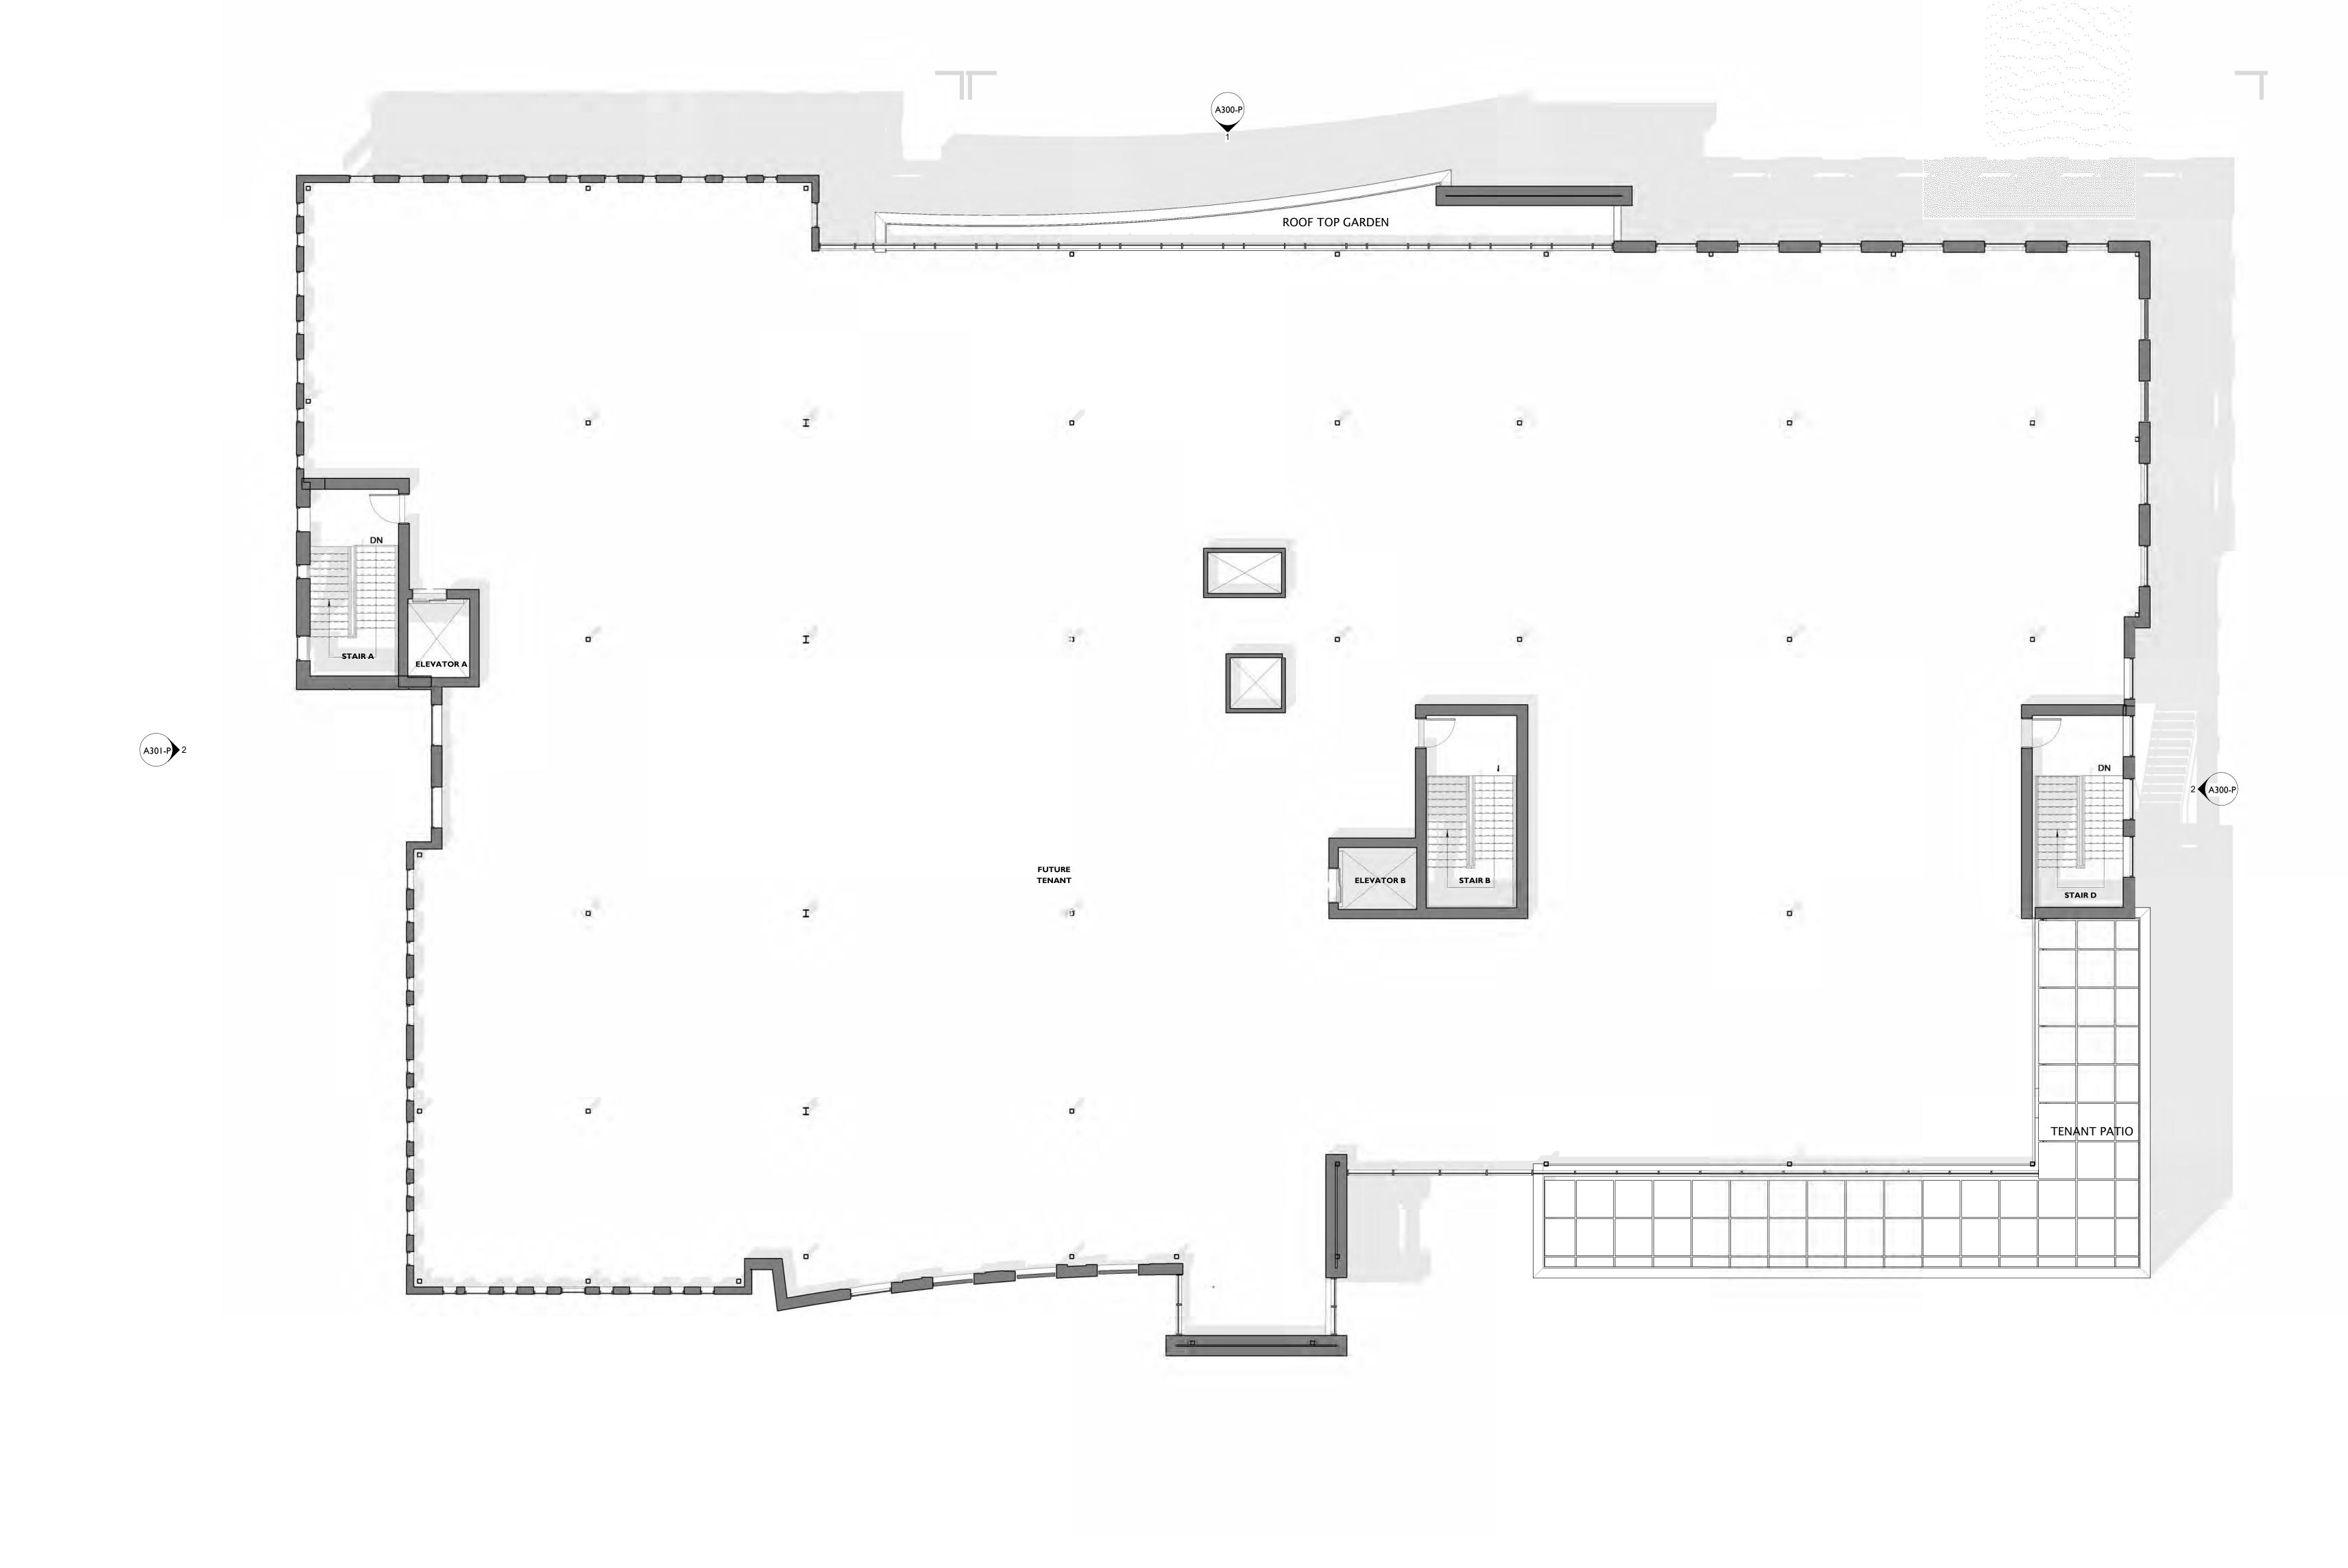

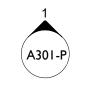










FLOOR PLAN - LEVEL 03

A203-P

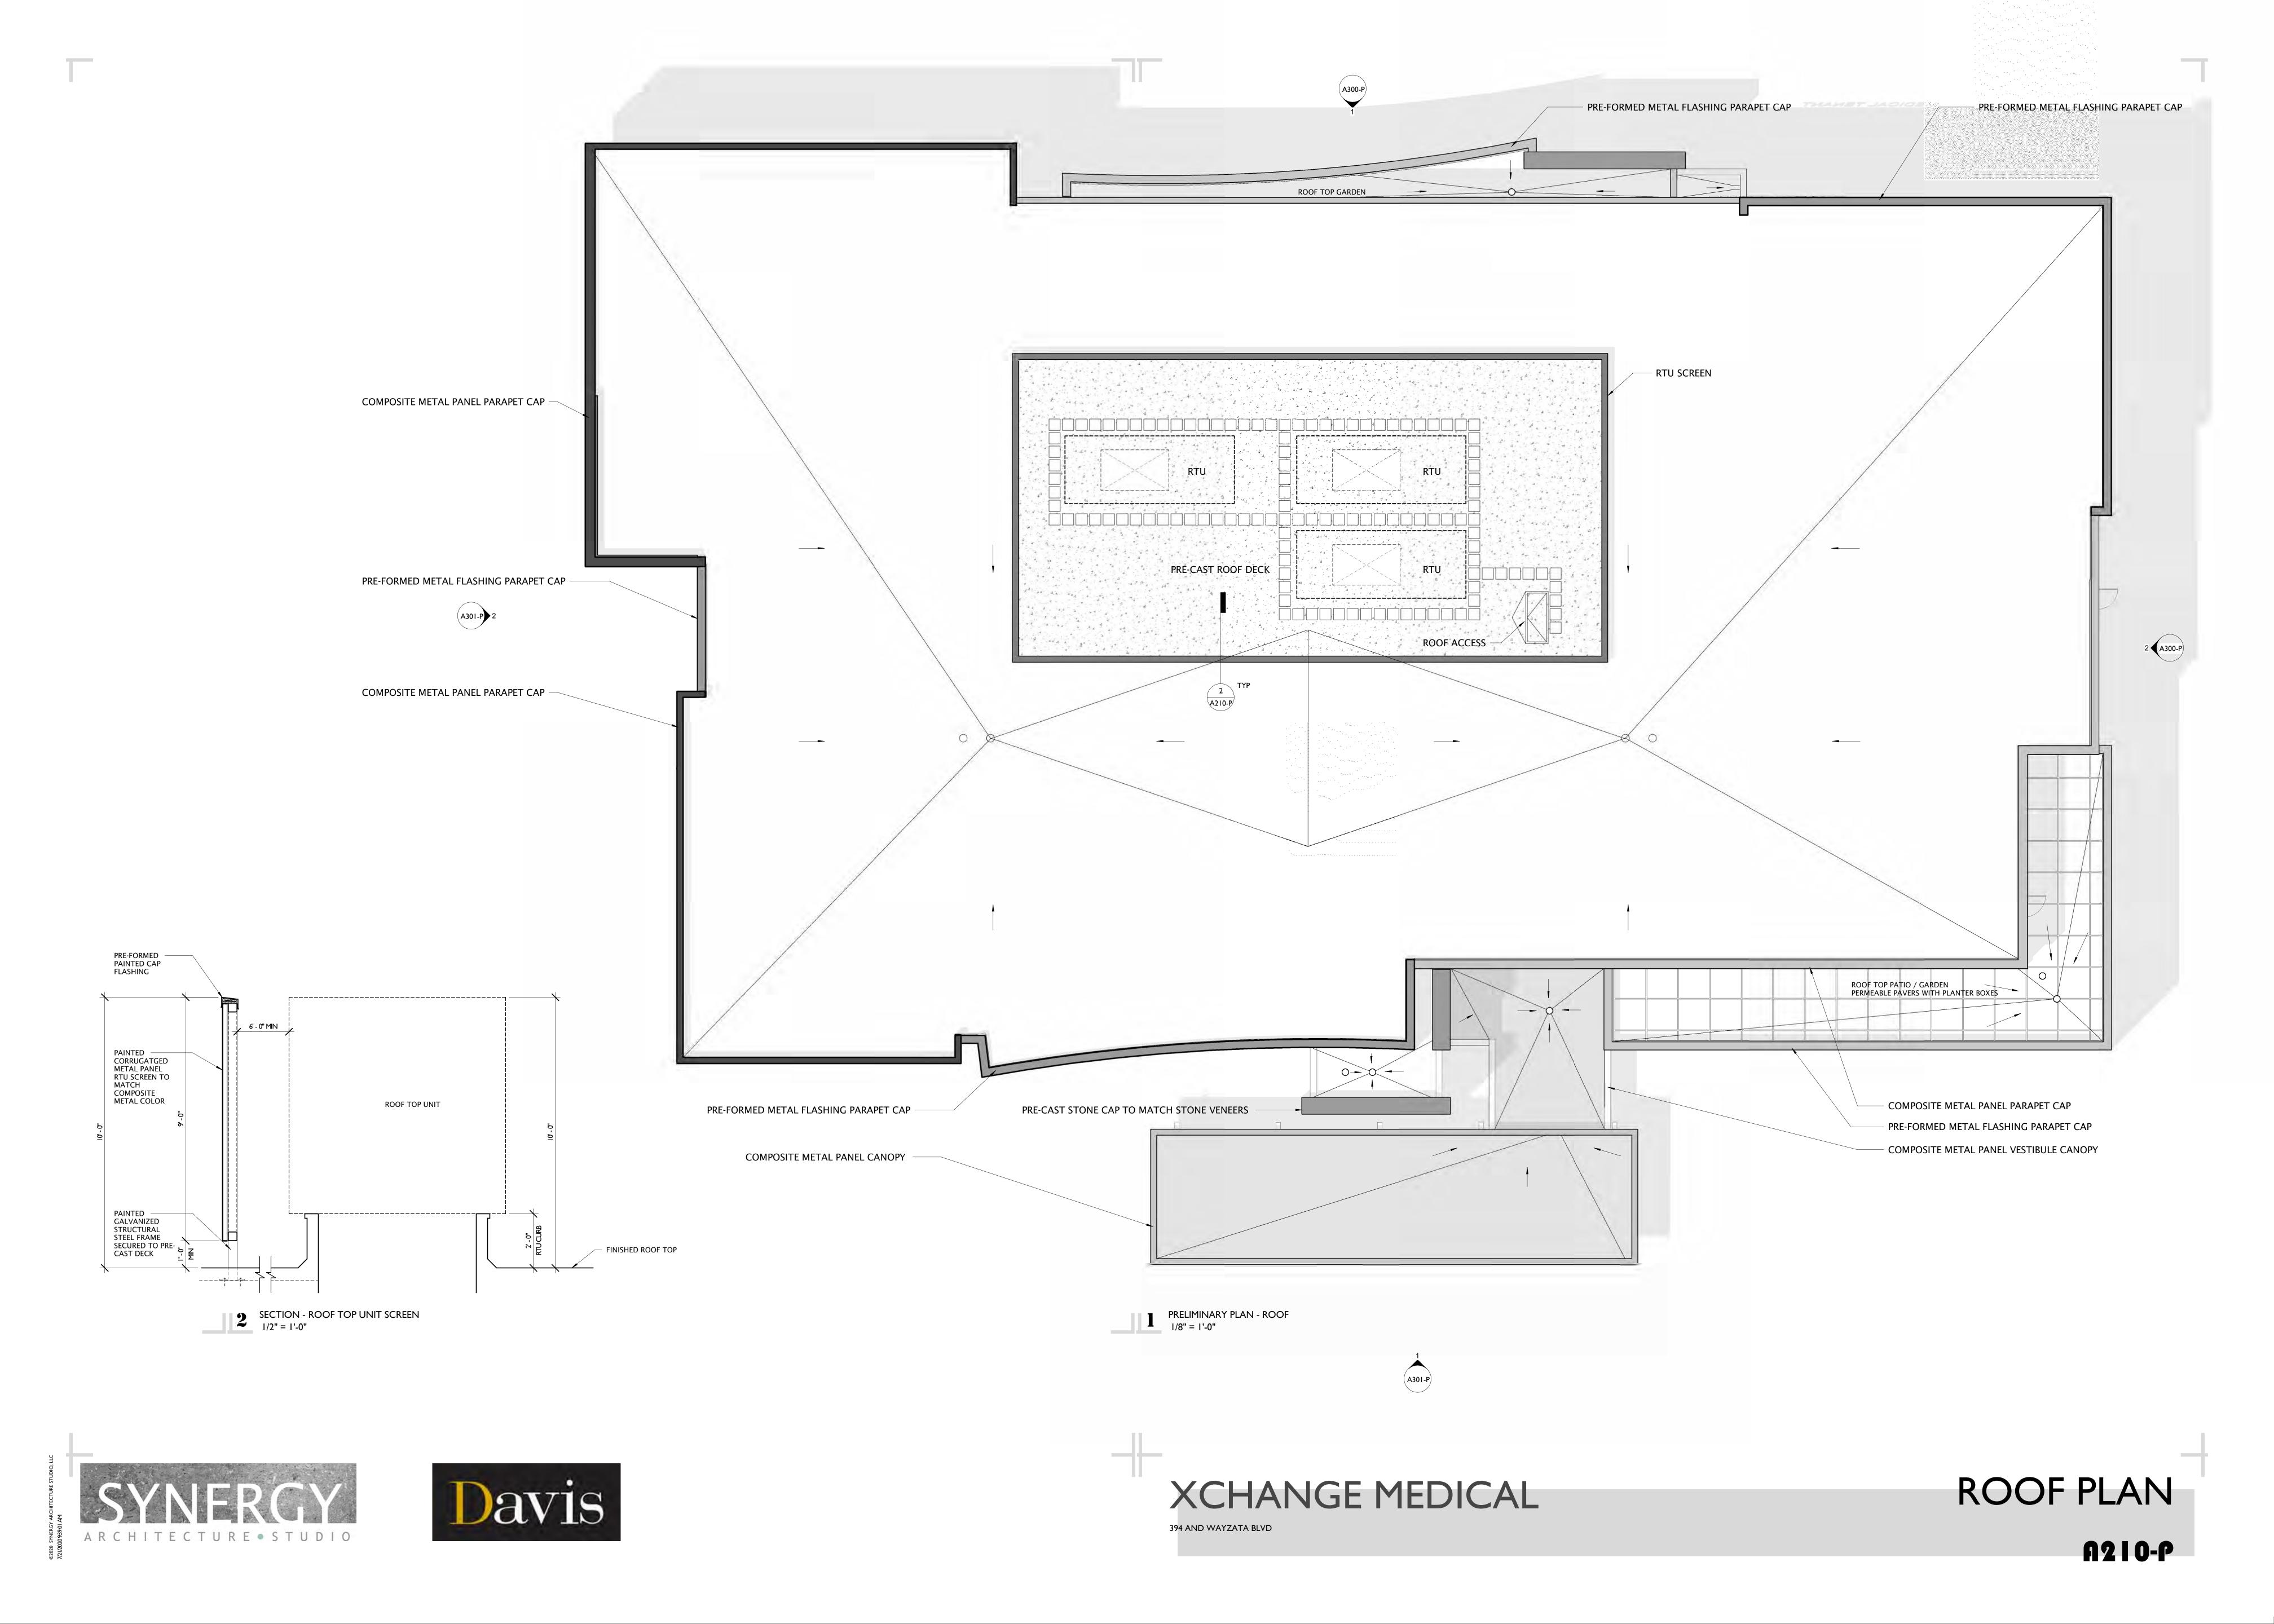

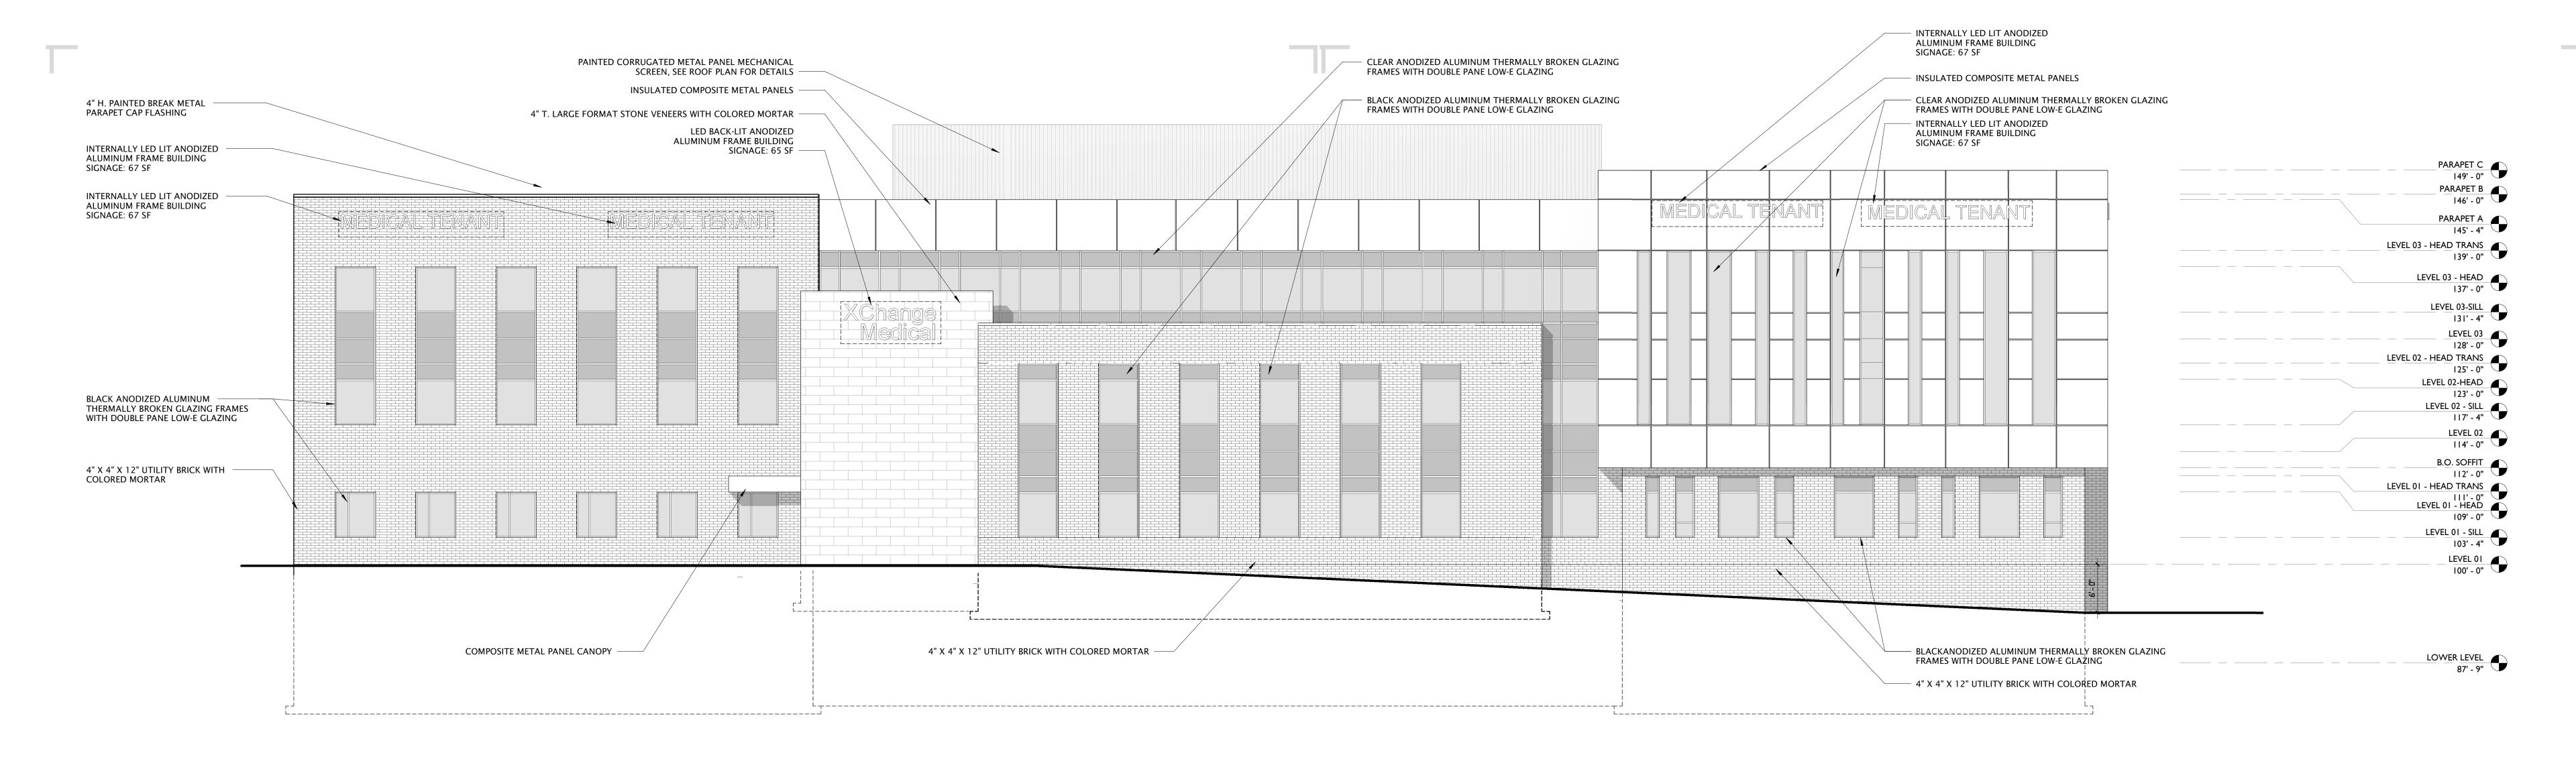

L ELEVATION - NORTH - PRESENTATION
1/8" = 1'-0"

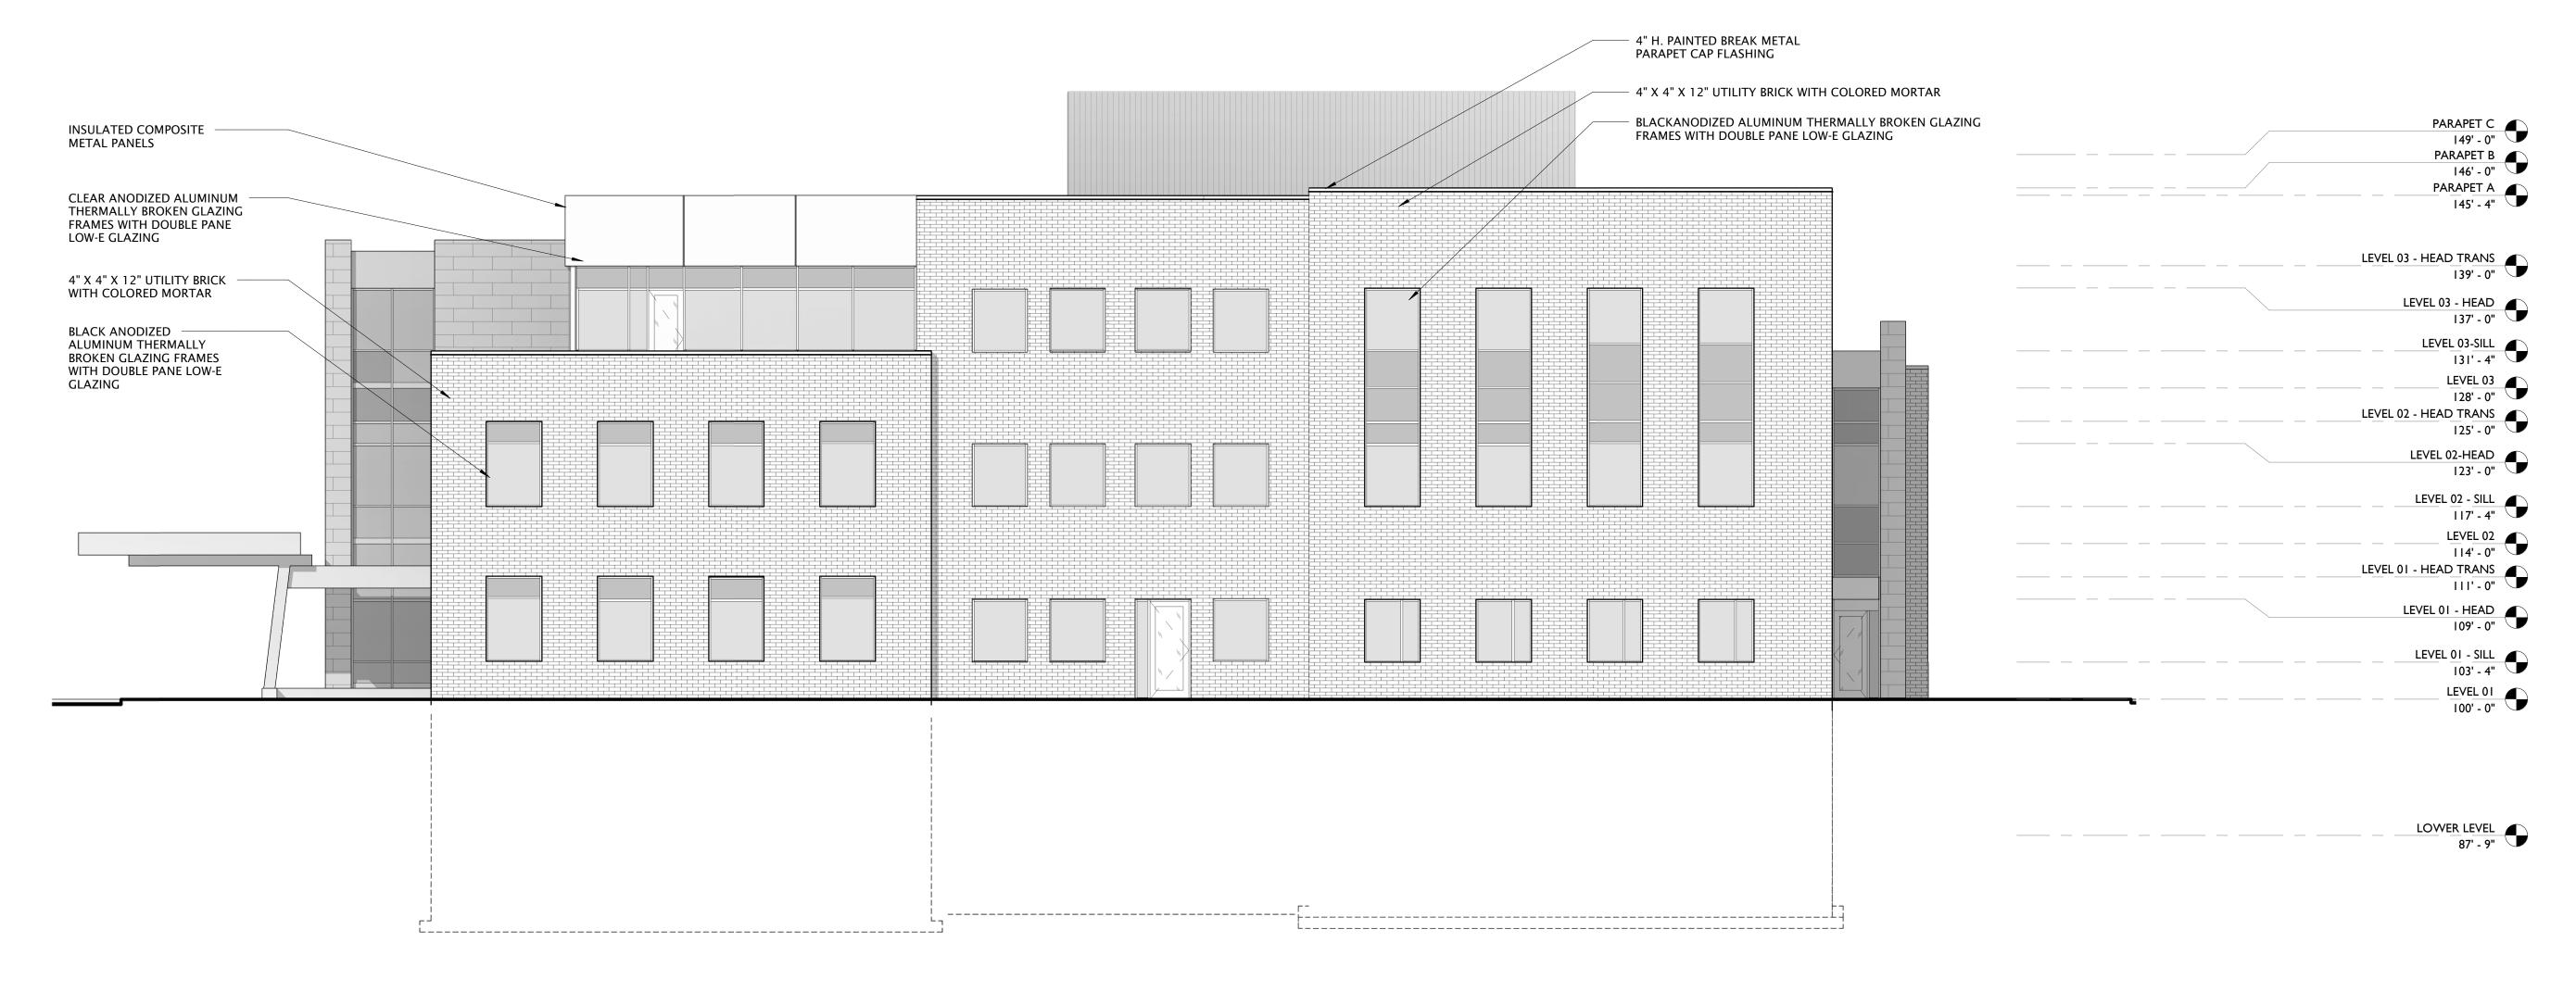


	PER SECTION 36-366						
MIN 60% CLASS I BUILDING MATERIALS PER ELEVATION VISIBILE FROM OFF-SITE.							
NORTH:	79% CLASS I MATERIALS						
BRICK	4,411 SF	41%					
STONE	774 SF	7%					
METAL PANEL		21%					
GLASS	3,306 SF	31%					
EAST:	97% CLASS I MATERIALS						
BRICK	4,002 SF	72%					
STONE	N/A	0%					
METAL PANEL		3%					
GLASS	1,425 SF	25%					
SOUTH:	82% CLASS I MATERIALS						
BRICK	4,191 SF	42%					
STONE	902 SF	9%					
METAL PANEL		18%					
GLASS	3,091 SF	31%					
WEST:	60% CLASS I MATERIALS						
BRICK	2,762 SF	36%					
STONE	N/A	0%					
METAL PANEL	3,069 SF	40%					
GLASS	1,841 SF	24%					
BUILDING TOTAL:	79% CLASS I MATERIALS						
BRICK	15,366	45%					
STONE	1,676	5%					
METAL PANEL		21%					
GLASS	9,663	29%					


ELEVATION - EAST - PRESENTATION 1/8" = 1'-0"







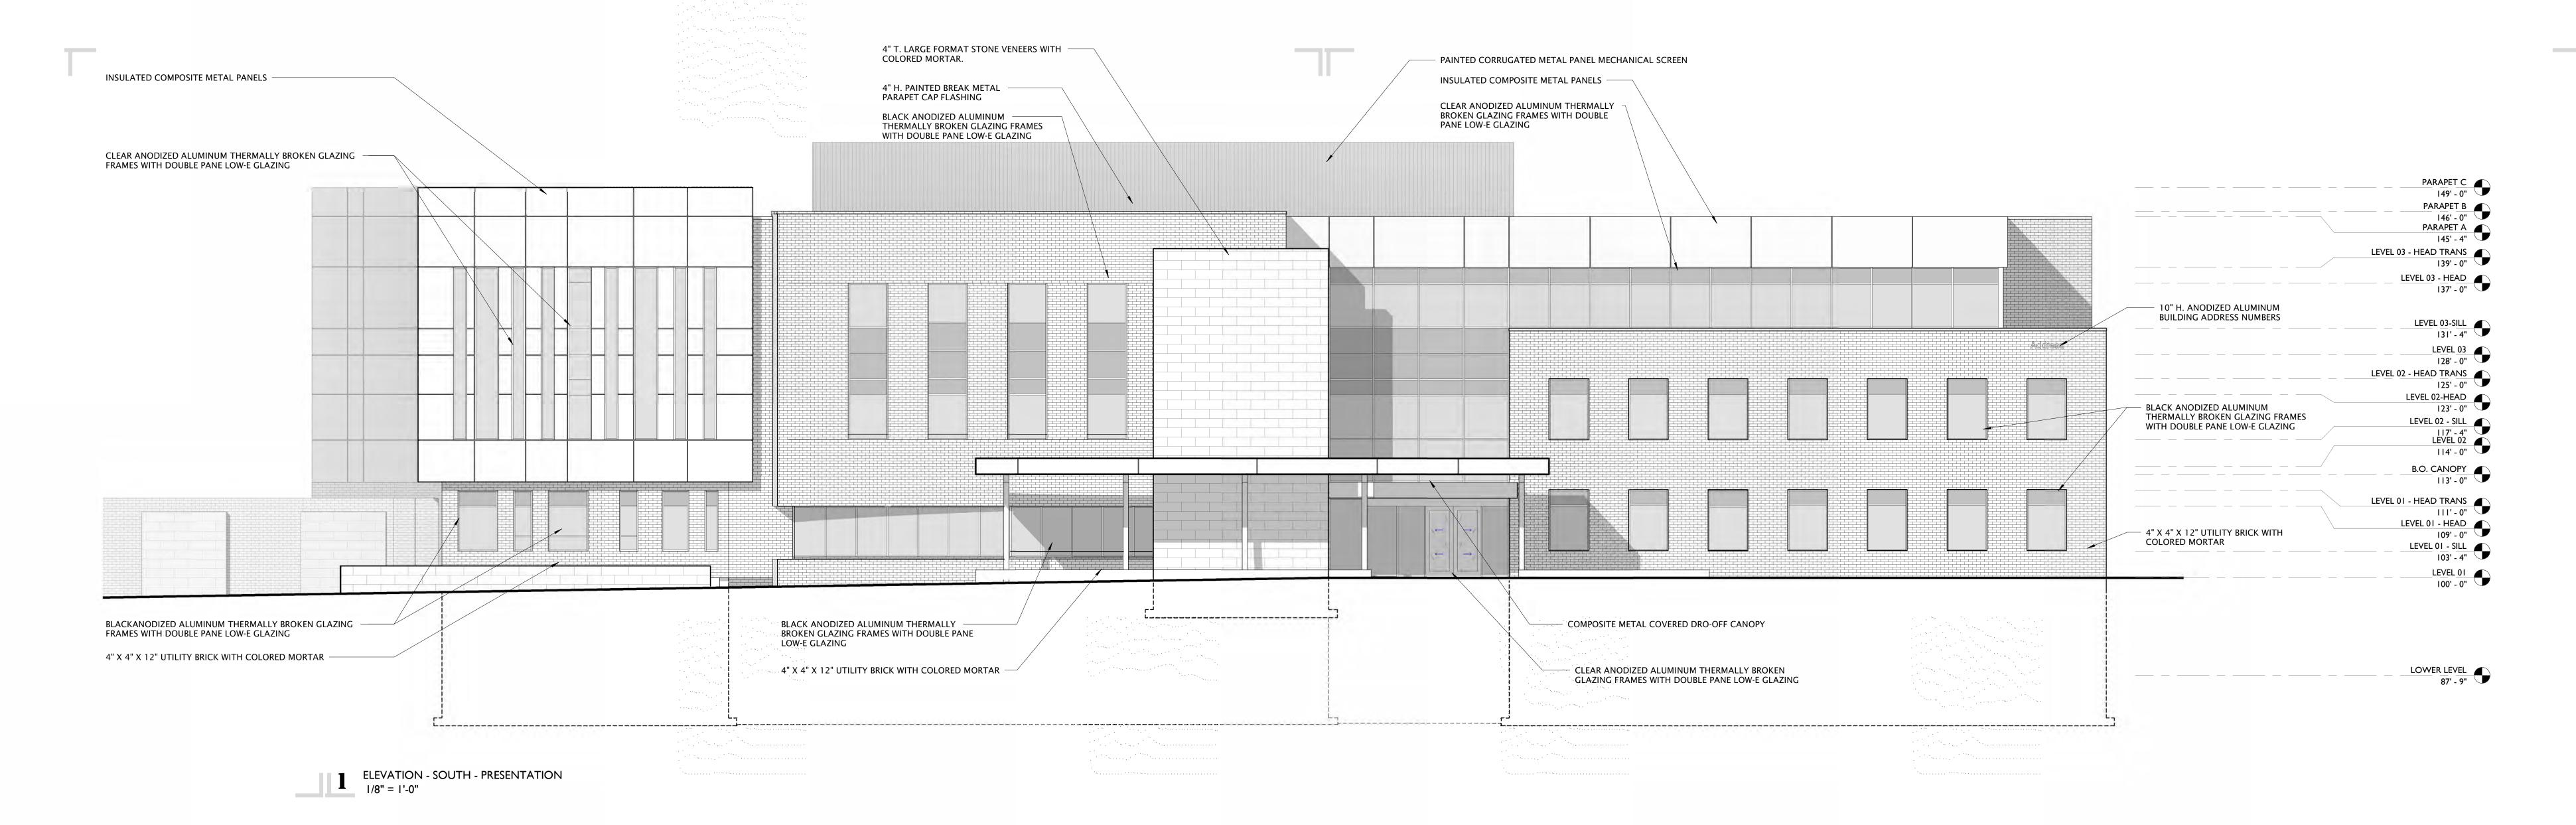

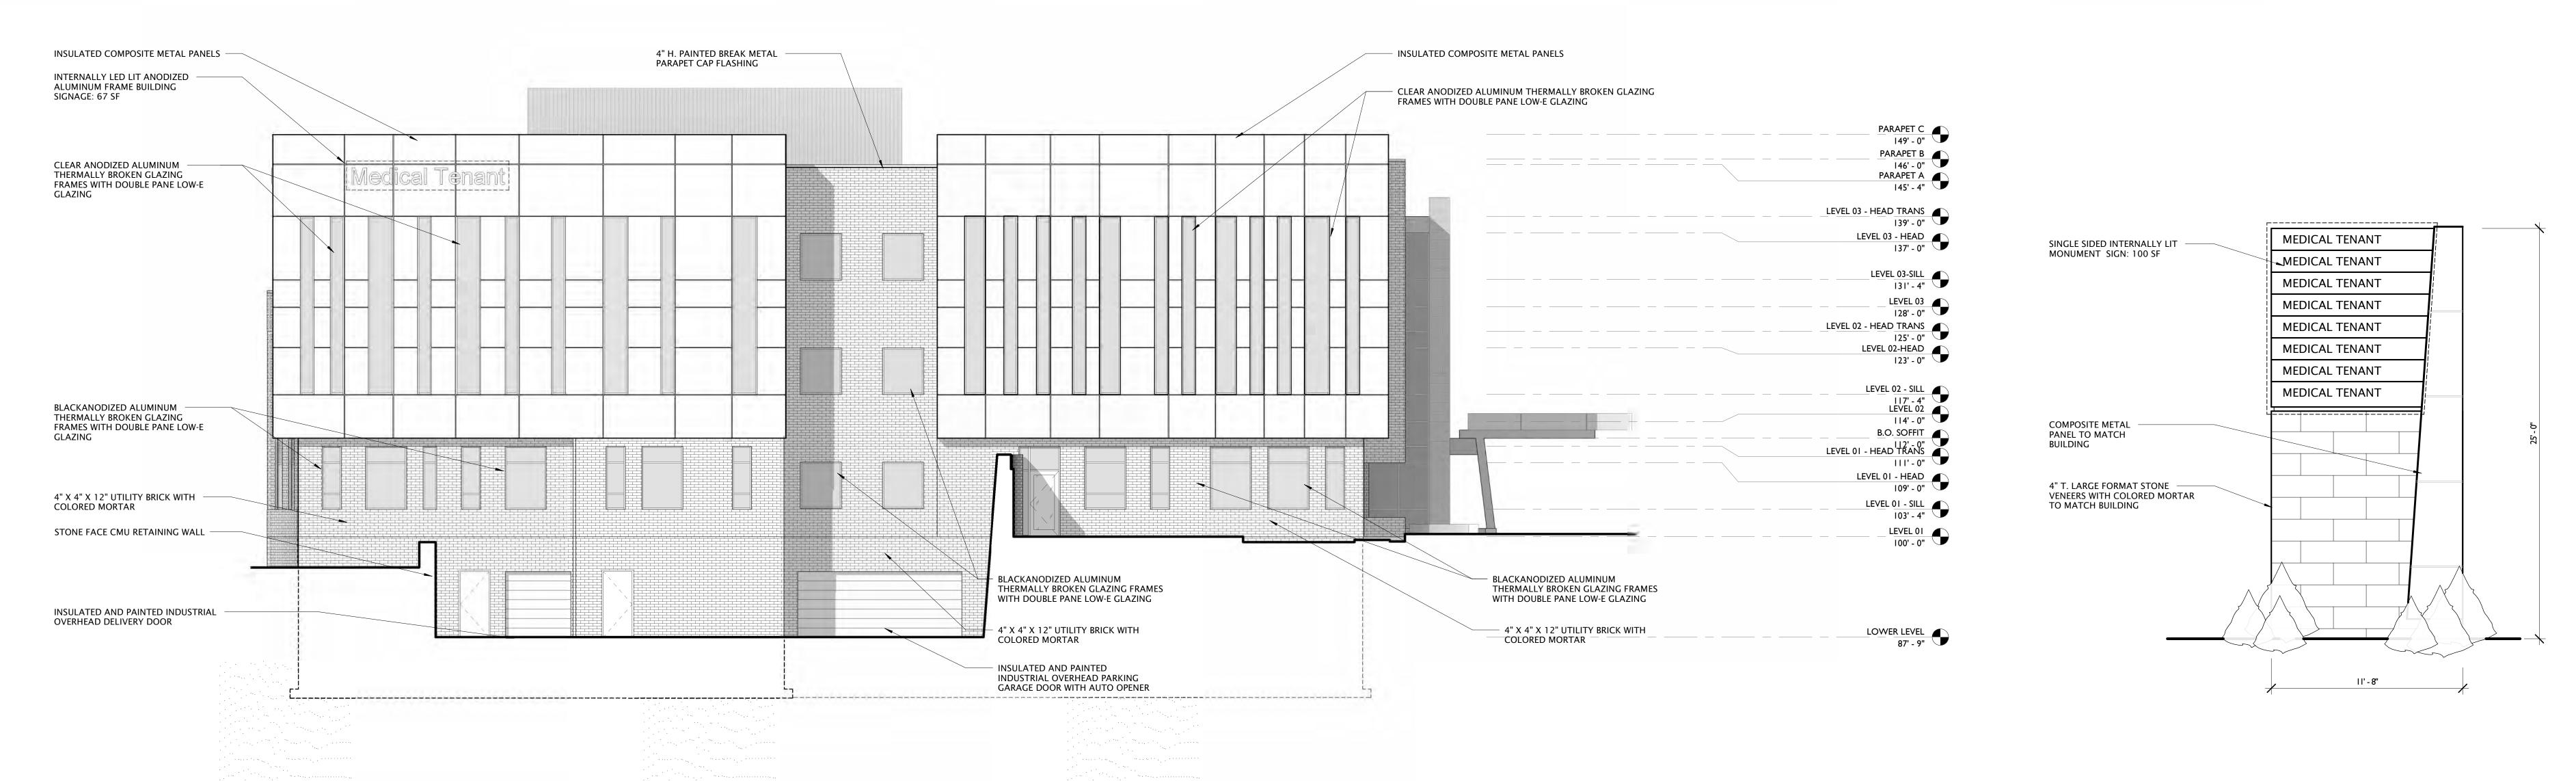





XCHANGE MEDICAL

394 AND WAYZATA BLVD

ELEVATIONS

ELEVATION - MONUMENT SIGN 1/4" = 1'-0"