


# 9920 WAYZATA BOULEVARD

St. Louis Park, Minnesota


WSB & Associates, Inc. Project No. .... 018843-000  
 Issue Date..... SEPTEMBER 07, 2021 PUD SUBMITTAL

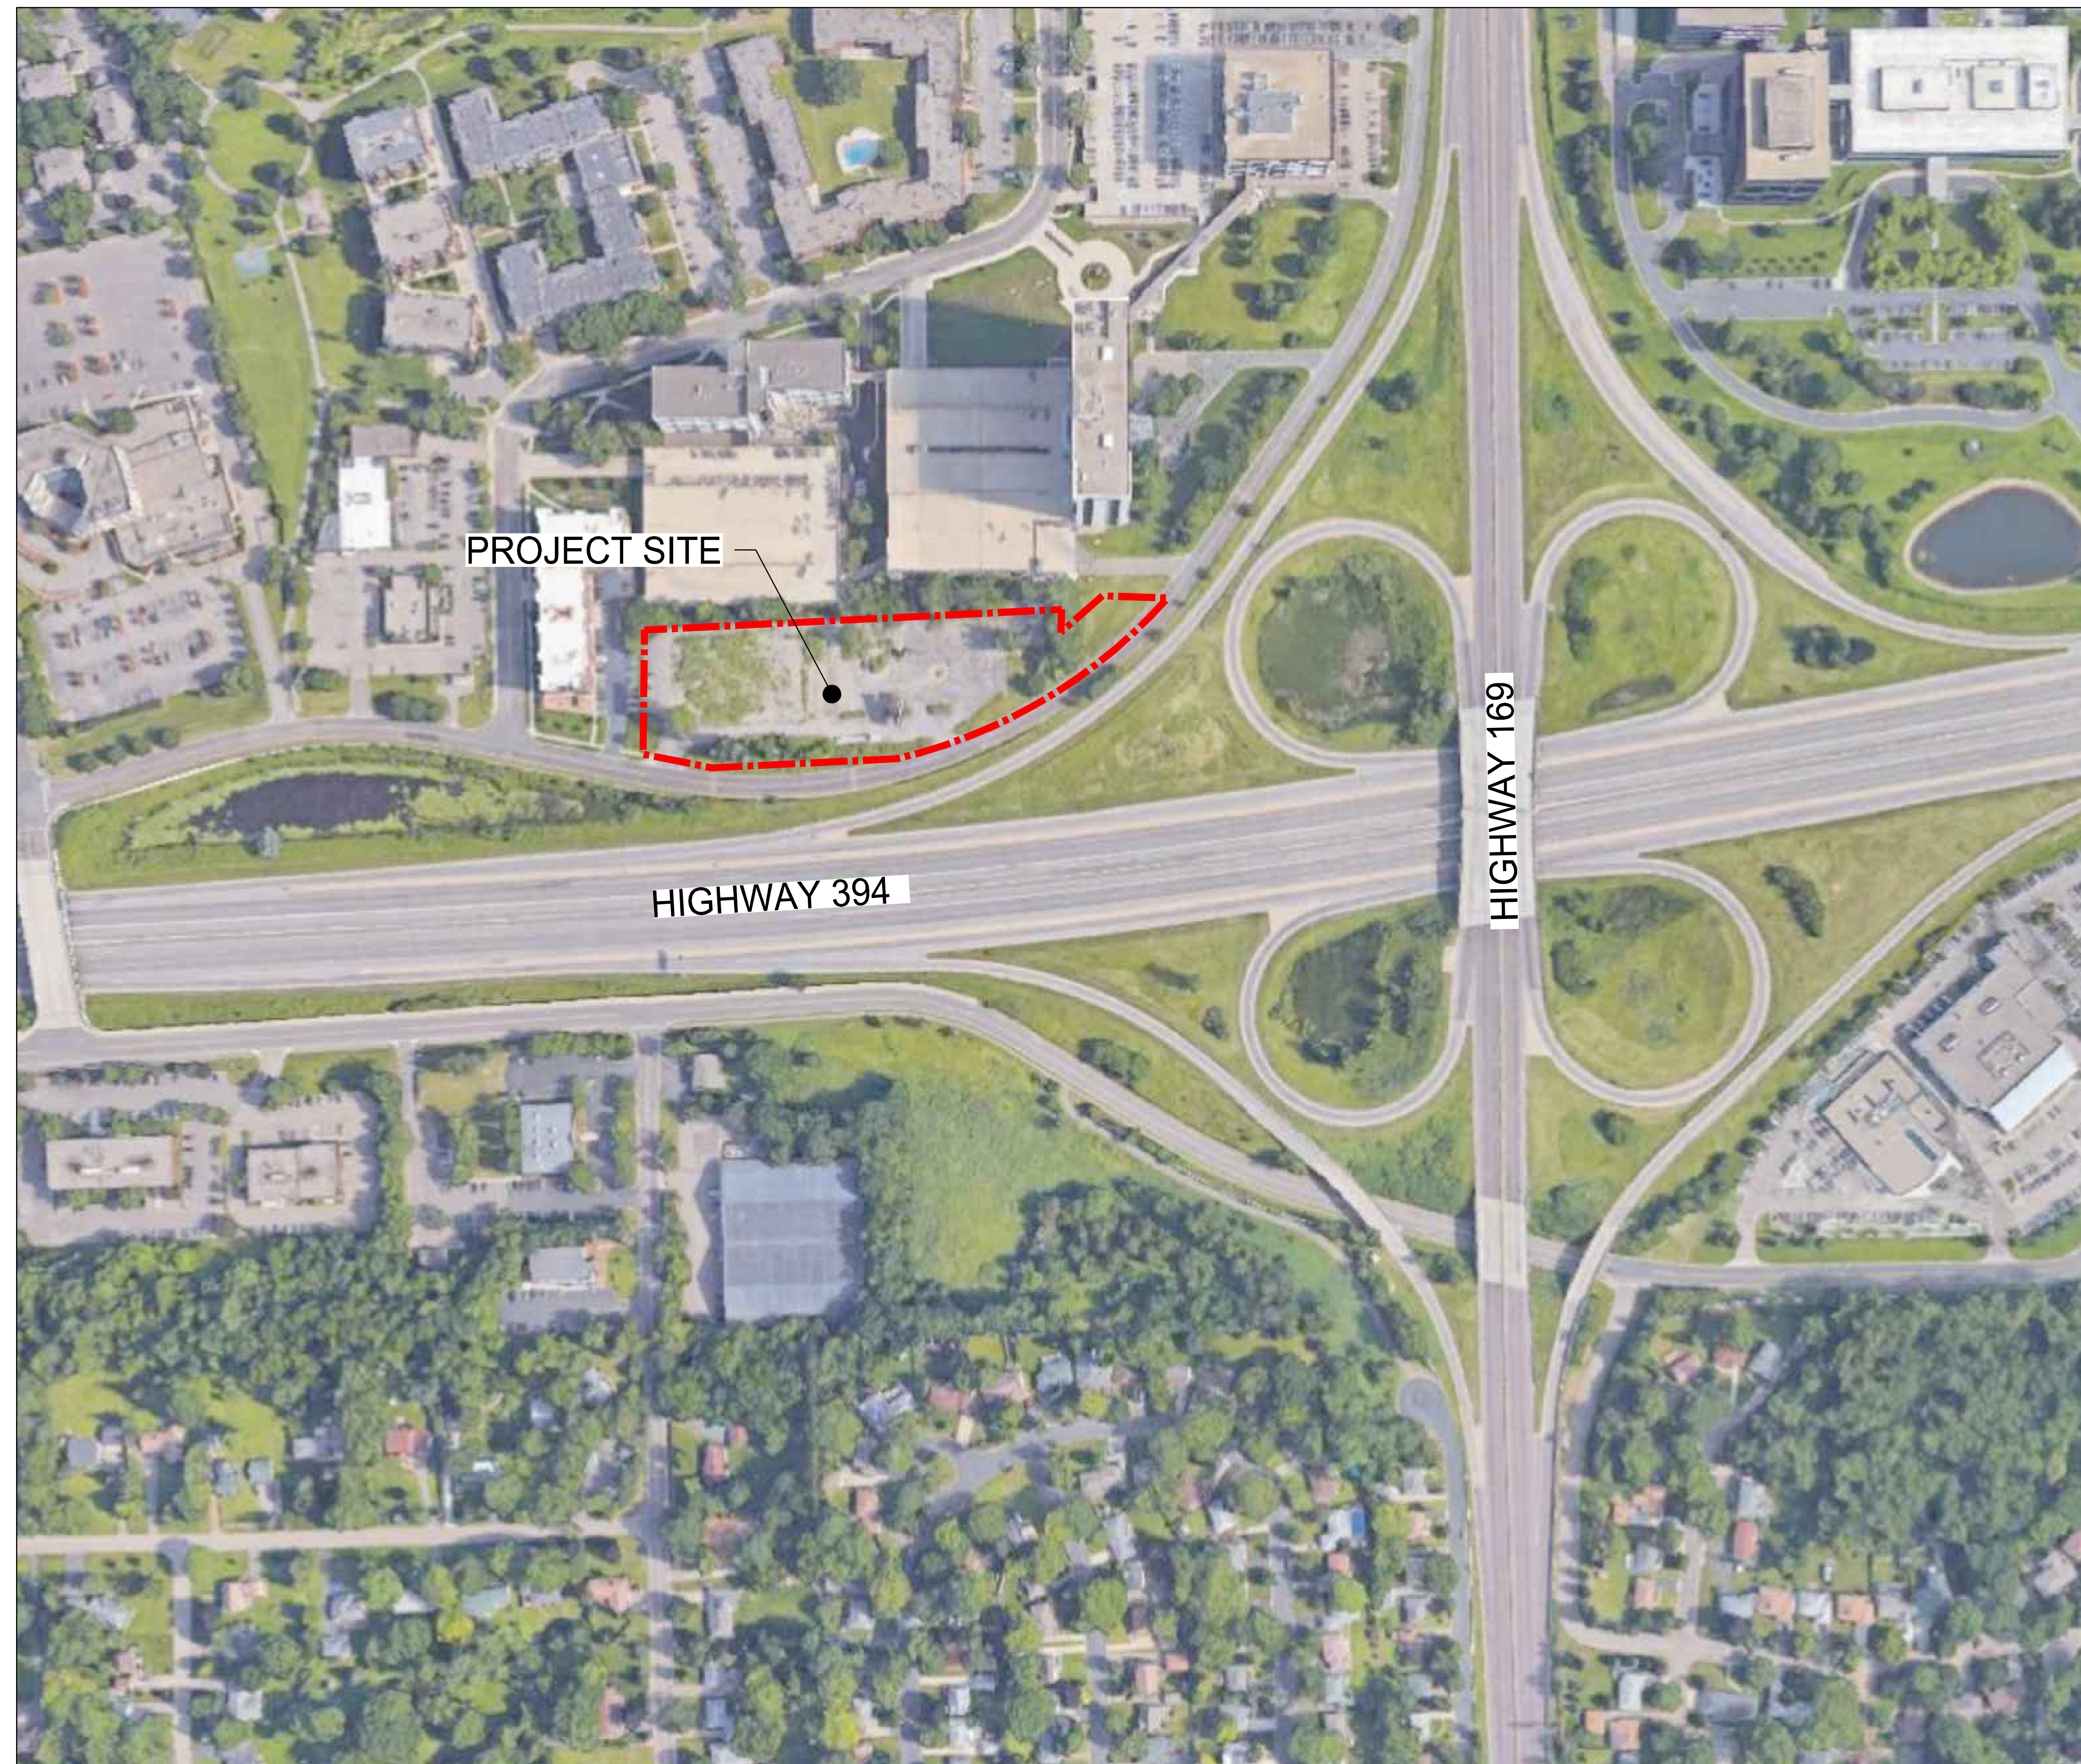

1 PROJECT LOCATION MAP  
 C0.00 SCALE: NOT TO SCALE

**UTILITY INFORMATION**

THE SUBSURFACE UTILITY INFORMATION SHOWN ON THESE DRAWINGS CONCERNING TYPE AND LOCATION OF PRIVATE UTILITIES HAS BEEN DESIGNATED UTILITY QUALITY LEVEL D. THESE QUALITY LEVELS WERE DETERMINED ACCORDING TO THE GUIDELINES OF C/ASCE 38-02, ENTITLED "STANDARD GUIDELINES FOR THE COLLECTION AND DEPICTION OF EXISTING SUBSURFACE DATA". THE CONTRACTOR IS TO DETERMINE THE TYPE AND LOCATION OF PRIVATE UTILITIES AS MAY BE DEEMED NECESSARY TO AVOID DAMAGE THERETO.

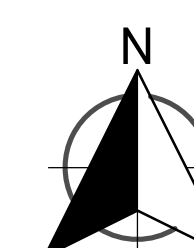

Sheet List Table	
SHEET NUMBER	SHEET TITLE
C0.00	COVER SHEET
C0.01	REMOVALS PLAN
C0.02	FIRE PLAN
C0.03	SITE PLAN
C0.04	SITE DETAILS
C0.05	SITE DETAILS
C0.06	SITE DETAILS
C0.07	GRADING PLAN
C0.08	EROSION CONTROL
C0.09	SWPPP
C0.10	EROSION DETAILS
C0.11	UTILITY PLAN
C0.12	UTILITY SERVICE PROFILES
C0.13	UTILITY DETAILS
C0.14	UTILITY DETAILS
C0.15	UTILITY DETAILS

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COVER SHEET

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TITLE  
**C0.00**

**GENERAL NOTES**


1. ALL WORK SHALL BE DONE IN ACCORDANCE WITH THE PLANS AND REQUIREMENTS OF THE DETAILED SPECIFICATIONS.
2. OBTAIN ALL NECESSARY PERMITS PRIOR TO CONSTRUCTION. THE CONTRACTOR SHALL PAY ALL PERMIT AND OTHER ASSOCIATED FEES REQUIRED BY LOCAL, STATE AND FEDERAL AGENCIES.
3. EXISTING SITE INFORMATION WAS TAKEN FROM A BOUNDARY AND TOPOGRAPHIC SURVEY COMPLETED BY GRONBERG & ASSOCIATES, INC., MINNESOTA, DATED JANUARY 3, 2017. ACTUAL FIELD CONDITIONS MAY VARY. VERIFY ALL FIELD CONDITIONS INCLUDING LOCATION OF UNDERGROUND UTILITIES PRIOR TO CONSTRUCTION. NOTIFY THE OWNER AND ARCHITECT OF ANY DISCREPANCIES AFFECTING THE SCOPE OF THIS CONTRACT. PROTECT ALL PROPERTY CORNERS. RELOCATE BENCHMARKS AS NECESSARY WITH NEW BENCHMARK LOCATIONS WITHIN A TOLERANCE OF 0.010 VERTICAL FEET.
4. THE CONTRACTOR SHALL VISIT THE SITE PRIOR TO SUBMITTING A BID TO BECOME FAMILIAR WITH ALL SITE CONDITIONS. ALL SURFACE FEATURES THAT CONFLICT WITH PROPOSED CONDITIONS SHALL BE REMOVED OR RELOCATED WHETHER OR NOT SHOWN ON SURVEY OR SPECIFICALLY CALLED OUT. THIS INCLUDES BUT IS NOT LIMITED TO CLEARING AND GRUBBING.
5. THE CONTRACTOR SHALL CONTACT THE LOCAL UTILITY MARKING AUTHORITY PRIOR TO CONSTRUCTION.

**GOVERNING SPECIFICATIONS (2017 SPECIFICATIONS)**

THE CITY OF ST. LOUIS PARK SHALL GOVERN ANY WORK IN THE RIGHT-OF-WAY.

ALL TRAFFIC CONTROL DEVICES SHALL CONFORM TO THE LATEST EDITION OF THE MINNESOTA MANUAL ON UNIFORM TRAFFIC CONTROL DEVICES (MUTCD), INCLUDING THE LATEST FIELD MANUAL FOR TEMPORARY TRAFFIC CONTROL ZONE LAYOUTS.

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**TREE INVENTORY LIST**

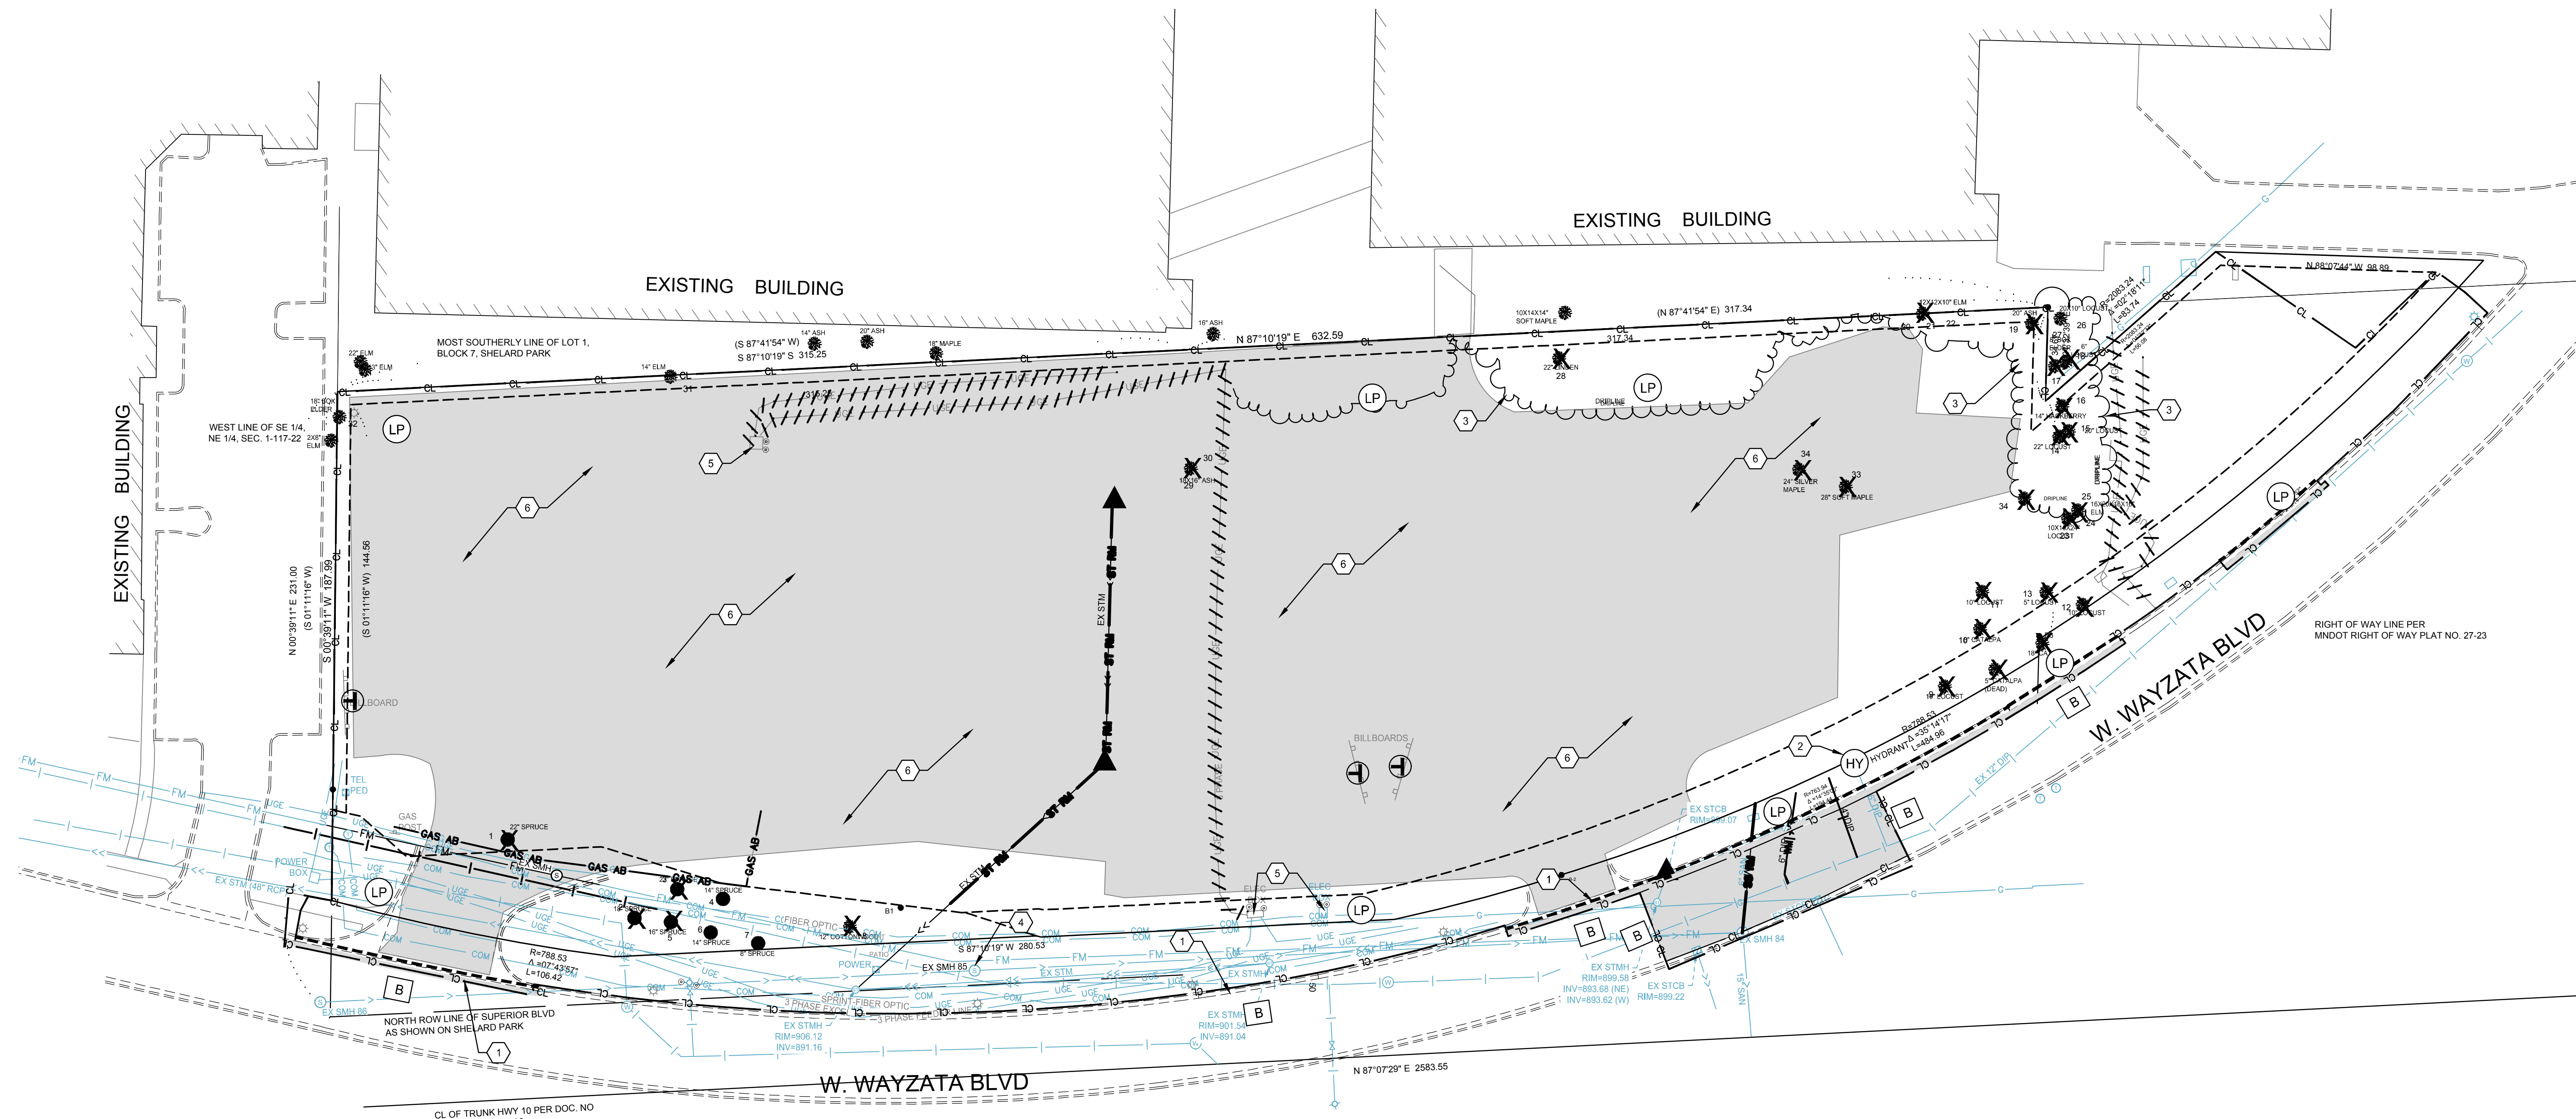ALL SIZES ARE IN INCHES AT D.B.H.  
 X = TO BE REMOVED

TREE #	SIZE	TYPE	CONDITION	TREE #	SIZE	TYPE	CONDITION		
1	X	22	SPRUCE	SIGNIFICANT	18	X	6	LOCUST	SIGNIFICANT
2	X	22	SPRUCE	SIGNIFICANT	19	X	20	ASH	COMMON
3	X	14	SPRUCE	SIGNIFICANT	20	X	12	ELM	COMMON
5	X	16	SPRUCE	SIGNIFICANT	21	X	12	ELM	COMMON
8	X	12	COTTONWOOD	SIGNIFICANT	22	X	10	ELM	COMMON
9	X	18	LOCUST	SIGNIFICANT	23	X	10	LOCUST	SIGNIFICANT
10	X	8	CATALPA	SIGNIFICANT	24	X	10	LOCUST	SIGNIFICANT
11	X	10	LOCUST	SIGNIFICANT	25	X	24	LOCUST	SIGNIFICANT
12	X	10	LOCUST	SIGNIFICANT	26	X	20	LOCUST	SIGNIFICANT
13	X	5	LOCUST	SIGNIFICANT	27	X	10	LOCUST	SIGNIFICANT
14	X	22	LOCUST	SIGNIFICANT	28	X	22	LINDEN	SIGNIFICANT
15	X	20	LOCUST	SIGNIFICANT	29	X	16	ASH	COMMON
16	X	14	HACKBERRY	SIGNIFICANT	30	X	18	ASH	COMMON
17	X	8	BOXELDER	COMMON	31	X	14	ELM	COMMON
					32	X	18	BOXELDER	COMMON

NOTE: TREES 4, 6 & 7 HAVE BEEN REMOVED FROM THIS LIST AND ARE TO BE PRESERVED. SEE LANDSCAPE PLANS FOR ADDITIONAL DETAIL.

**LEGEND**

SIGNIFICANT - AN TREE AT LEAST 5 CALIPER INCHES (DECIDUOUS) OR 6 CALIPER INCHES (CONIFEROUS) OR GREATER IN EXCELLENT CONDITION, OR ANY TREE THE CITY HAS A STRONG DESIRE TO PRESERVE. THIS INCLUDES ASPEN, COTTONWOOD, OR SILVER MAPLE AT LEAST 12 CALIPER INCHES DBH IN HEALTHY CONDITION.

COMMON - ANY OF THE FOLLOWING TREES: WILLOW, SIBERIAN ELM, BOX ELDER, BLACK LOCUST OR ASPEN, COTTONWOOD, OR SILVER MAPLE UNDER 12 CALIPER INCHES, OR OTHER FAST GROWING DECIDUOUS TREES NOT LISTED AS AN SIGNIFICANT TREE INCLUDING TREES IN POOR PHYSICAL CONDITION.

**SUMMARY**

ABOUT HALF OF ALL TREES CURRENTLY GROWING ON THE SITE ARE COMMON TREES. THESE TREES CARRY LOW VALUE IN EFFORTS FOR PRESERVATION AND ARE BETTER TO BE REMOVED AND NEW HARDWOOD TREES BE PLANTED AS PART OF THE ZONING REQUIREMENTS.

THERE ARE TWO "EXCEPTIONAL" TREES ON THE SITE BUT ARE SMALLER IN SIZE NOT MAKING THEM "SIGNIFICANT" TREES. BOTH OF THESE TREES ARE LOCATED IN PROPOSED PARKING AREAS. THESE CATALPA TREE IS NOT NATIVE TO THE SITE AND HAVE BEEN PLANTED AS PART OF THE PREVIOUS SITE DEVELOPMENT PROJECT. THE HACKBERRY TREE POTENTIALLY IS A VOLUNTEER GROWING IN A LARGER WOODED GROVE OF TREES.

THERE "SIGNIFICANT" TREES WHICH ARE LOCATED ON SITE. MANY OF THEM ARE WITHIN PROPOSED PARKING AREAS OR IN THE PROPOSED FIRE LANE AND TRASH ACCESS LANE. MANY OF THESE TREES HAVE BEEN PLANTED AS PART OF PREVIOUS SITE DEVELOPMENT PARKING LOT REQUIREMENTS. SOME OF THE OTHER TREES ARE GROWING IN A GROVES OF OTHER LOW VALUE COMMON TREES AND HAVE A POOR OVERALL STRUCTURE AND VALUE TO THE SITE. AGAIN, MOST OF THESE TREES WOULD BE BETTER TO BE REMOVED AND REPLACED WITH HIGHER QUALITY HARDWOOD TREES MEETING CURRENT ZONING REQUIREMENTS.

**DEMOLITION NOTES**

- THE CONTRACTOR SHALL VISIT THE SITE PRIOR TO SUBMITTING A BID TO BECOME FAMILIAR WITH ALL SITE CONDITIONS. ALL SURFACE FEATURES THAT CONFLICT WITH PROPOSED CONDITIONS SHALL BE REMOVED OR RELOCATED WHETHER OR NOT SHOWN ON SURVEY OR SPECIFICALLY CALLED OUT. THIS INCLUDES BUT IS NOT LIMITED TO CLEARING AND GRUBBING.
- EROSION AND SEDIMENT CONTROL MEASURES ARE TO BE INSTALLED PRIOR TO THE COMMENCEMENT OF CONSTRUCTION (SEE GRADING AND DRAINAGE PLAN).
- MAINTAIN FIRE ACCESS WITHIN 150 FEET OF EXTERIOR AREAS OF ALL BUILDINGS DURING CONSTRUCTION.
- THE CONTRACTOR SHALL REFER TO THE MUTCD FOR TRAFFIC CONTROL REQUIREMENTS. THE CONTRACTOR MAY BE REQUIRED TO PHASE CONSTRUCTION TO MINIMIZE DISRUPTION TO TRAFFIC AND MAINTAIN SITE SAFETY. CONSTRUCTION OPERATIONS SHALL BE PERFORMED IN A WAY TO MINIMIZE THE DISRUPTION TO THE NORMAL FLOW OF TRAFFIC ON ALL STREETS, ALLEYS, AND PUBLIC BUILDING ACCESS.
- THE CONTRACTOR SHALL OBTAIN AND CONFORM TO ALL PERTINENT CITY, COUNTY AND STATE DETAILS, SPECIFICATIONS, PERMITS, AND COORDINATE INSPECTIONS AS REQUIRED BY THE GOVERNING BODY DURING THE ENTIRE PROJECT DURATION
- CONTACT PUBLIC AND PRIVATE UTILITY OWNERS A MINIMUM OF 72 HOURS PRIOR TO THE START OF WORK. IT SHALL BE THE CONTRACTOR'S RESPONSIBILITY TO LOCATE AND PROTECT ALL EXISTING UTILITIES AND TOPOGRAPHIC FEATURES NOT SCHEDULED FOR REMOVAL. NO ADDITIONAL PAYMENT WILL BE MADE FOR REPAIRING DAMAGE TO EXISTING UTILITIES, RELOCATING, WORKING AROUND, OR PROTECTING EXISTING UTILITIES OR OTHER APPURTENANCES.
- COORDINATE WITH PRIVATE UTILITY COMPANIES (ELECTRIC, GAS, COMMUNICATIONS) FOR TERMINATION REMOVAL AND OR RELOCATION OF EXISTING SERVICES THROUGHOUT SITE AND REPLACEMENT WITH NEW SERVICES FOR THE PROPOSED DEVELOPMENT.
- REMOVE TOPSOIL WITHIN LIMITS OF CONSTRUCTION. STOCKPILE ON-SITE FOR USE IN AREAS NOT SCHEDULED FOR BUILDING, PAVEMENT, OR SIDEWALK.
- A DIAMOND EDGE SAWBLADE SHALL BE USED FOR CUTTING ALL PAVEMENT MARKED FOR REMOVAL.
- SAWCUT EXISTING PAVEMENT WHICH ABUTS ALL NEW PAVEMENTS TO PROVIDE A STRAIGHT VERTICAL EDGE.
- PROTECT BY WHATEVER MEANS REQUIRED ALL FENCES, SIGNS, STRUCTURES, DRIVES, SIDEWALKS, STREETS, BUSHES, TREES, ETC. WHICH ARE NOT DESIGNATED FOR REMOVAL, OR OUTSIDE THE LIMITS OF CONSTRUCTION.
- CONTRACTOR IS RESPONSIBLE FOR REPAIRING ALL DAMAGE INCURRED DURING CONSTRUCTION. THIS INCLUDES, BUT IS NOT LIMITED TO, DAMAGE CAUSED BY SUBCONTRACTORS TO THE GENERAL CONTRACTOR. REPAIRS SHALL EQUAL OR EXCEED THE QUALITY OF EXISTING CONDITIONS.
- CONTRACTOR SHALL REMOVE AND/OR RELOCATE ALL ITEMS NECESSARY TO ACCOMMODATE THE PROPOSED IMPROVEMENTS WHETHER SPECIFICALLY CALLED OUT BY NOTE OR NOT.
- THE LOCATIONS OF ALL AERIAL AND UNDERGROUND UTILITY FACILITIES ARE APPROXIMATE OR MAY NOT BE INDICATED IN THESE PLANS. UNDERGROUND FACILITIES, WHETHER INDICATED OR NOT, SHALL BE LOCATED PRIOR TO CONSTRUCTION. IT SHALL BE THE RESPONSIBILITY OF THE CONTRACTOR TO PROTECT ALL EXISTING UTILITIES, PAVEMENT AND OTHER IMPROVEMENTS. ANY DAMAGE TO EXISTING UTILITIES AND/OR PAVED STREETS CAUSED BY CONSTRUCTION OPERATIONS SHALL BE REPAIRED OR REPLACED AT THE CONTRACTOR'S EXPENSE, IN ACCORDANCE WITH ST. LOUIS PARK PUBLIC WORKS DEPARTMENT STANDARD SPECIFICATIONS FOR CONSTRUCTION, LATEST EDITION.
- ALL DEBRIS AND REFUSE RESULTING FROM CONSTRUCTION OPERATIONS SHALL BE HAULED OFF-SITE AND DISPOSED OF PROPERLY AT THE CONTRACTOR'S EXPENSE.
- CONTRACTOR SHALL KEEP EXISTING SANITARY SEWER FORCE MAIN IN SERVICE UNTIL NEW FORCE MAIN IS INSTALLED.

**KEYNOTES**


- COORDINATE REMOVAL OF BITUMINOUS PAVING WITH CONSTRUCTION SCHEDULE.
- REMOVE EXISTING HYDRANT. INSTALL NEW HYDRANT IN ACCORDANCE WITH SHEET CU101.
- REMOVE ALL TREES AND VEGETATION WITH THE PROPOSED IMPROVEMENTS. CONTRACTOR TO FIELD VERIFY.
- ADJUST EXISTING SANITARY SEWER CASTING. SEE SHEET CU501.
- PROVIDED SURVEY DOES NOT INCLUDE EXISTING PAVEMENT AND CURB THAT STILL EXISTS THROUGHOUT SITE AND MUST BE REMOVED. CONTRACTOR IS RESPONSIBLE FOR VERIFYING EXTENT OF REQUIRED REMOVALS PRIOR TO BID.

**LEGEND (EXISTING)**

	EXISTING CONTOURS
	EXISTING WATERMAIN
	EXISTING WATER MANHOLE
	EXISTING SANITARY SEWER
	EXISTING SANITARY SEWER MANHOLE
	EXISTING SANITARY SEWER FORCE MAIN
	EXISTING STORM SEWER
	EXISTING STORM SEWER MANHOLE/CATCH BASIN
	EXISTING UNDERGROUND TELEPHONE
	EXISTING TELEPHONE MANHOLE
	EXISTING UNDERGROUND ELECTRIC
	EXISTING OVERHEAD ELECTRIC
	EXISTING UNDERGROUND GAS
	EXISTING TREES

**REMOVAL LEGEND**

	REMOVE ALL PAVEMENT, CURBING AND CONCRETE WALK
	CONSTRUCTION LIMITS
	SAW CUT BITUMINOUS PAVEMENT (FULL DEPTH)
	ABANDON GAS SUPPLY LINE
	REMOVE UTILITY
	REMOVE SANITARY SEWER
	REMOVE STORM SEWER
	REMOVE WATERMAIN
	REMOVE CURB & GUTTER
	REMOVE SANITARY STRUCTURE
	REMOVE HYDRANT, VALVE AND LEAD
	REMOVE LIGHT POLE
	REMOVE DRAINAGE STRUCTURE
	REMOVE TREE

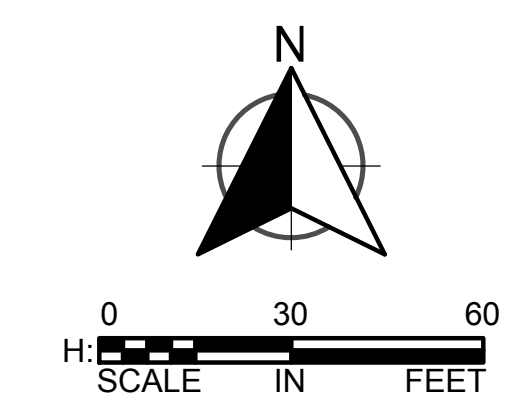

**PUD APPLICATION**

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


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**REMOVALS PLAN**

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TITLE  
**C0.01**

LEGEND

-  ASPHALT PAVEMENT (HEAVY DUTY)
-  ADA LANDING
-  ADA ROUTE




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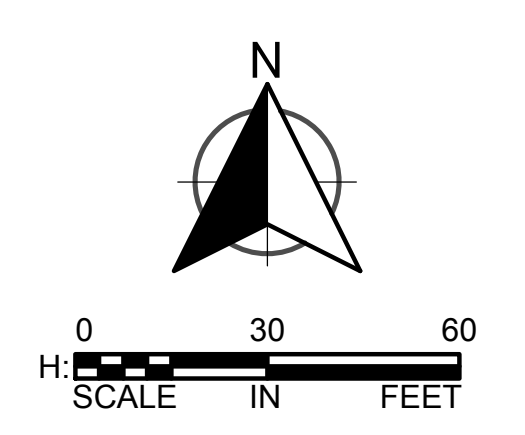
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**FIRE PLAN**

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 TITLE  
**C0.02**




- KEYNOTES**
- 1 B624 CURB AND GUTTER. (SEE DETAIL 3 & 4/C0.05)
  - 2 B618 CURB AND GUTTER. (SEE DETAIL 3/C0.05)
  - 3 ASPHALT PAVEMENT, LIGHT DUTY. (SEE DETAIL 8/C0.05)
  - 4 CONCRETE PAVEMENT. (SEE DETAIL 7/C0.05)
  - 5 CONCRETE SIDEWALK. (SEE DETAILS 2/C0.05)
  - 6 PAINTED PARKING STRIPE, 4" WIDE, WHITE; TYPICAL.
  - 7 THICKENED BITUMINOUS EDGE. (SEE DETAIL 1/C0.05)
  - 8 ACCESSIBLE PARKING STALL(S) (SEE DETAILS 3/C0.06)
  - 9 COMMERCIAL DRIVE APRON. (SEE DETAIL 1/C0.04)
  - 10 BICYCLE RACK(S) (SEE DETAIL 1/C0.06)
  - 11 RETAINING WALL (DESIGN AND DETAIL BY OTHERS).
  - 12 GENERATOR PAD. (SEE ARCHITECTURAL PLANS)
  - 13 ELECTRICAL TRANSFORMER PAD. (SEE ARCHITECTURAL PLANS)
  - 14 ASPHALT PAVEMENT (HEAVY DUTY). (SEE DETAIL 9/C0.05)
  - 15 MULTI LANE ROAD REPAIR. (SEE DETAIL 6/C0.04)
  - 16 TRENCH DRAIN.
  - 17 R-TANK STORMWATER RETENTION FACILITY.

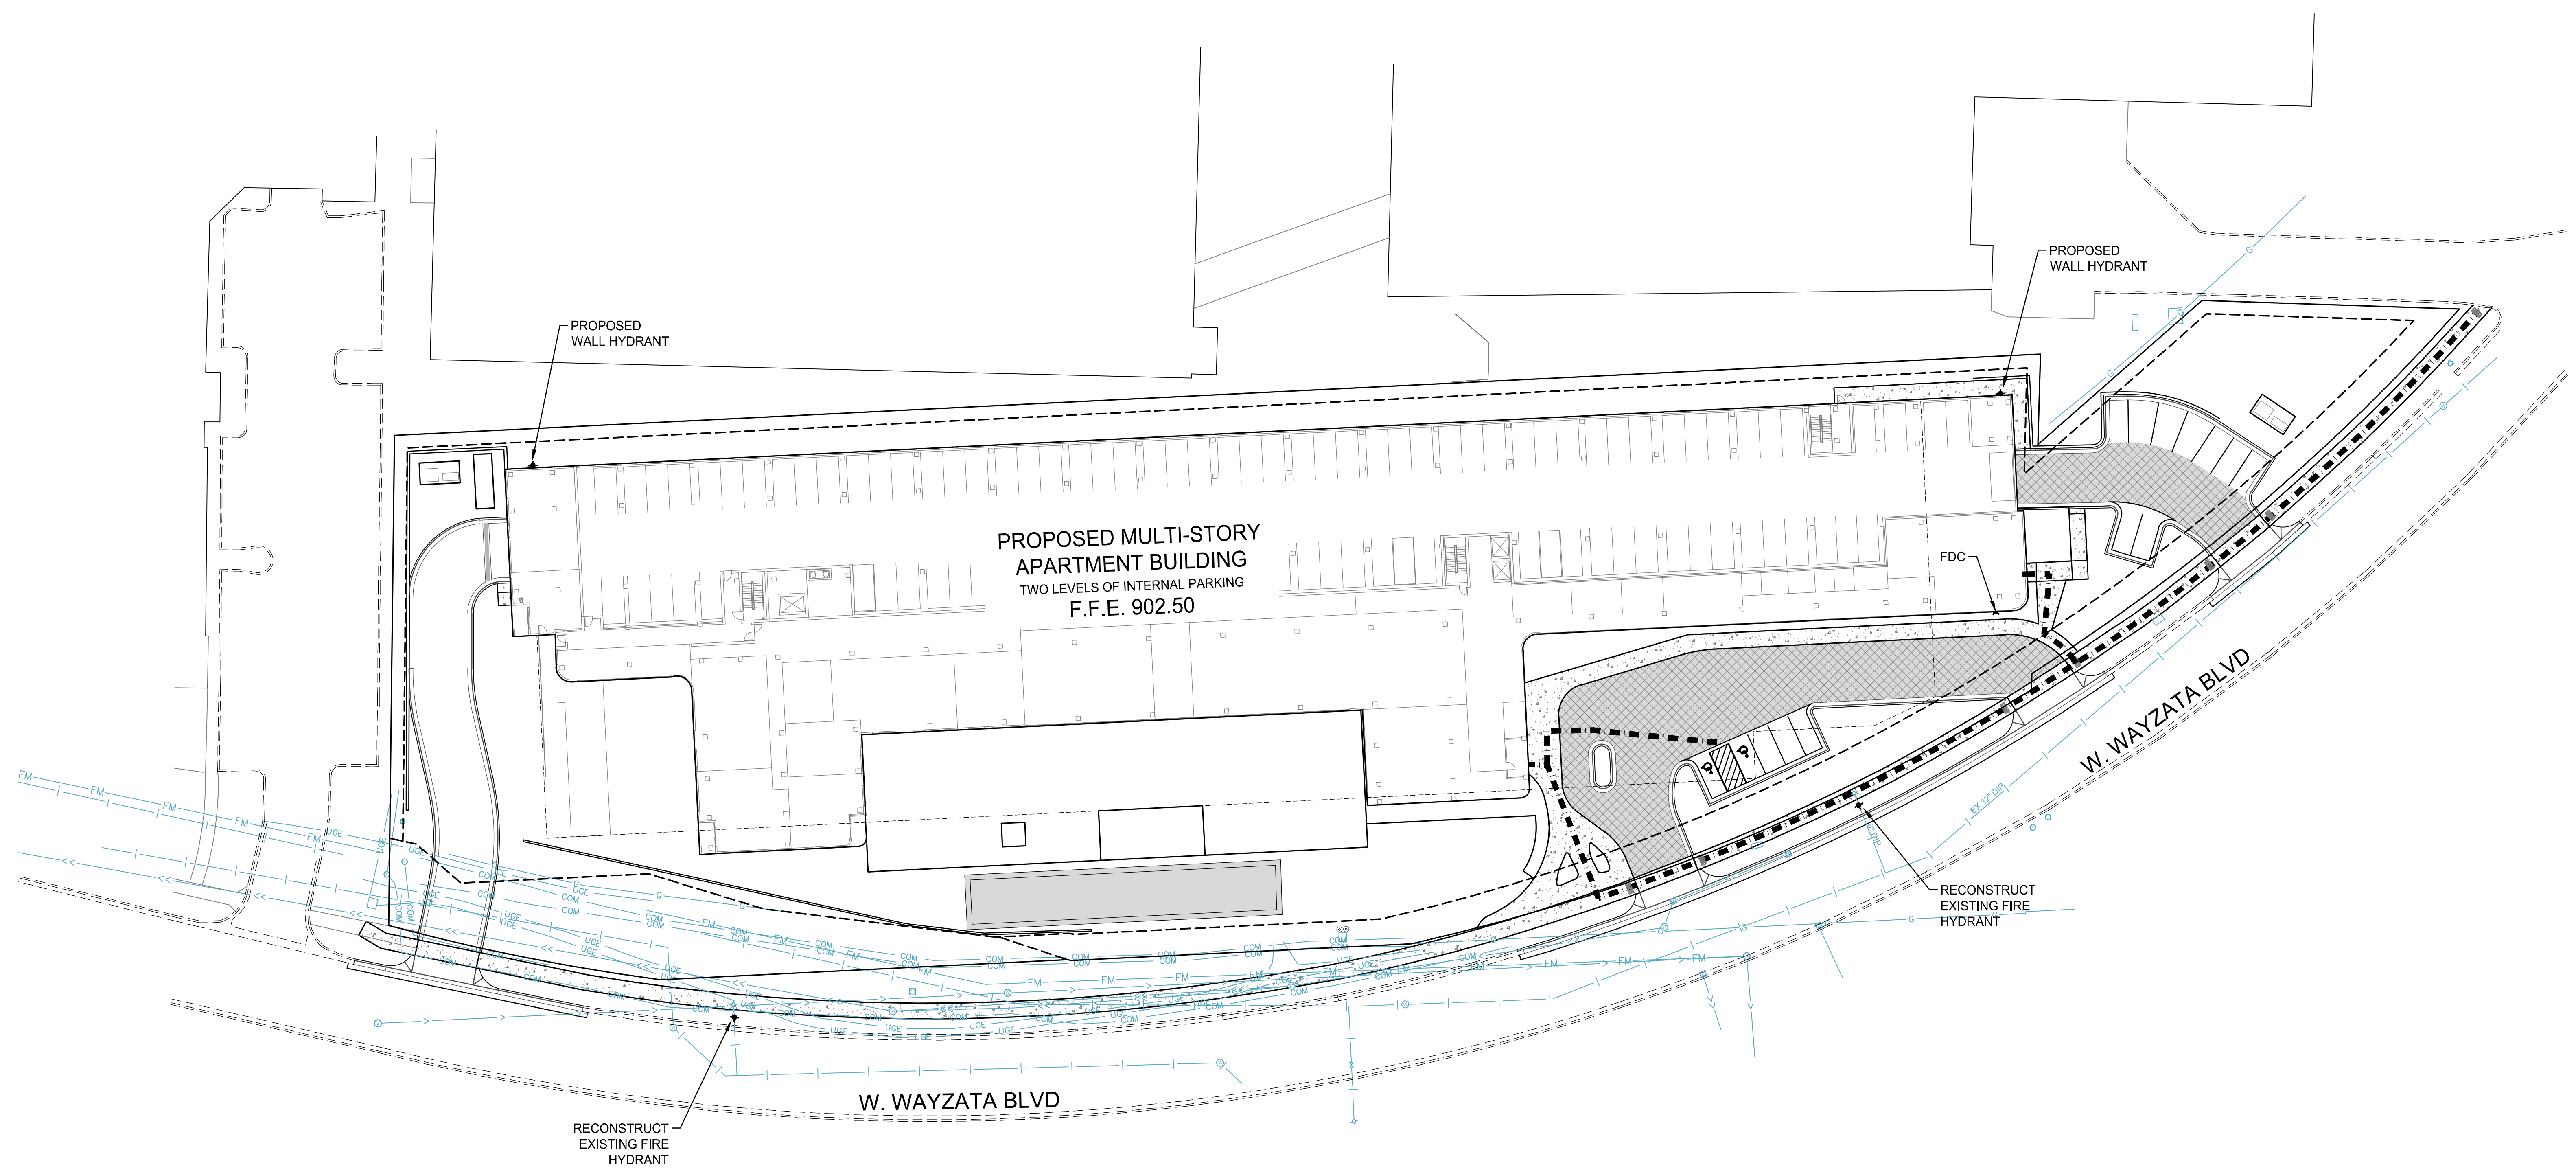- DIMENSIONAL PARKING STANDARDS**
- STANDARD PARKING STALL DIMENSION - 8.5FT x 18FT  
 COMPACT PARKING STALL DIMENSION - 8FT X 15FT  
 ACCESSIBLE PARKING STALL DIMENSION - 8FT x 18FT  
 MINIMUM DRIVE ISLE WIDTH (TWO WAY) - 24 FT
- PARKING SUMMARY**  
 SEE ARCHITECTURAL SITE PLAN

- SITE PLAN NOTES**
1. SEE SHEET C0.00 FOR CIVIL GENERAL NOTES.
  2. SEE SHEET C0.01 FOR EXISTING CONDITIONS & DEMOLITION PLAN.
  3. SEE ARCHITECTURAL PLAN AND LANDSCAPE PLANS FOR ADDITIONAL SITE PLAN FEATURES.
  4. PATCH EXISTING STREET PAVEMENTS TO MATCH EXISTING STRUCTURAL SECTION WHEN INSTALLING CURB AND DRIVEWAYS.
  5. THE CONTRACTOR SHALL CONSTRUCT ALL PAVEMENTS TO CONFORM WITH THE CORRECT LINES AND FINISHED GRADES AS INDICATED ON THE PLANS AND TO MATCH EXISTING PAVEMENT GRADES AT TIE-IN POINTS. NO PONDING OF WATER WILL BE ALLOWED.
  6. SAW ALL CONCRETE CONSTRUCTION JOINTS, CLEAN THEM OF DEBRIS, BLOW THEM DRY AND IMMEDIATELY SEAL WITH JOINT SEALANT.
  7. DIMENSIONS ARE TO FACE OF CURB, EDGE OF PAVEMENT AND EXTERIOR FINISH FACE OF STRUCTURES UNLESS OTHERWISE NOTED.

**LEGEND**

	ASPHALT PAVEMENT (HEAVY DUTY)
	ASPHALT PAVEMENT (LIGHT DUTY)
	CONCRETE WALK
	CONCRETE PAVEMENT
	PARKING COUNT
	EXISTING WATER MAIN
	EXISTING WATER MANHOLE
	EXISTING HYDRANT
	EXISTING SANITARY SEWER
	EXISTING SANITARY SEWER MANHOLE
	EXISTING SANITARY SEWER FORCE MAIN
	EXISTING STORM SEWER
	EXISTING STORM SEWER MANHOLE/CATCH BASIN
	EXISTING UNDERGROUND TELEPHONE
	EXISTING TELEPHONE MANHOLE
	EXISTING UNDERGROUND ELECTRIC
	EXISTING OVERHEAD ELECTRIC
	EXISTING UNDERGROUND GAS
	EXISTING TREES
	UTILITY EASEMENT LINE
	BUILDING SETBACK LINE

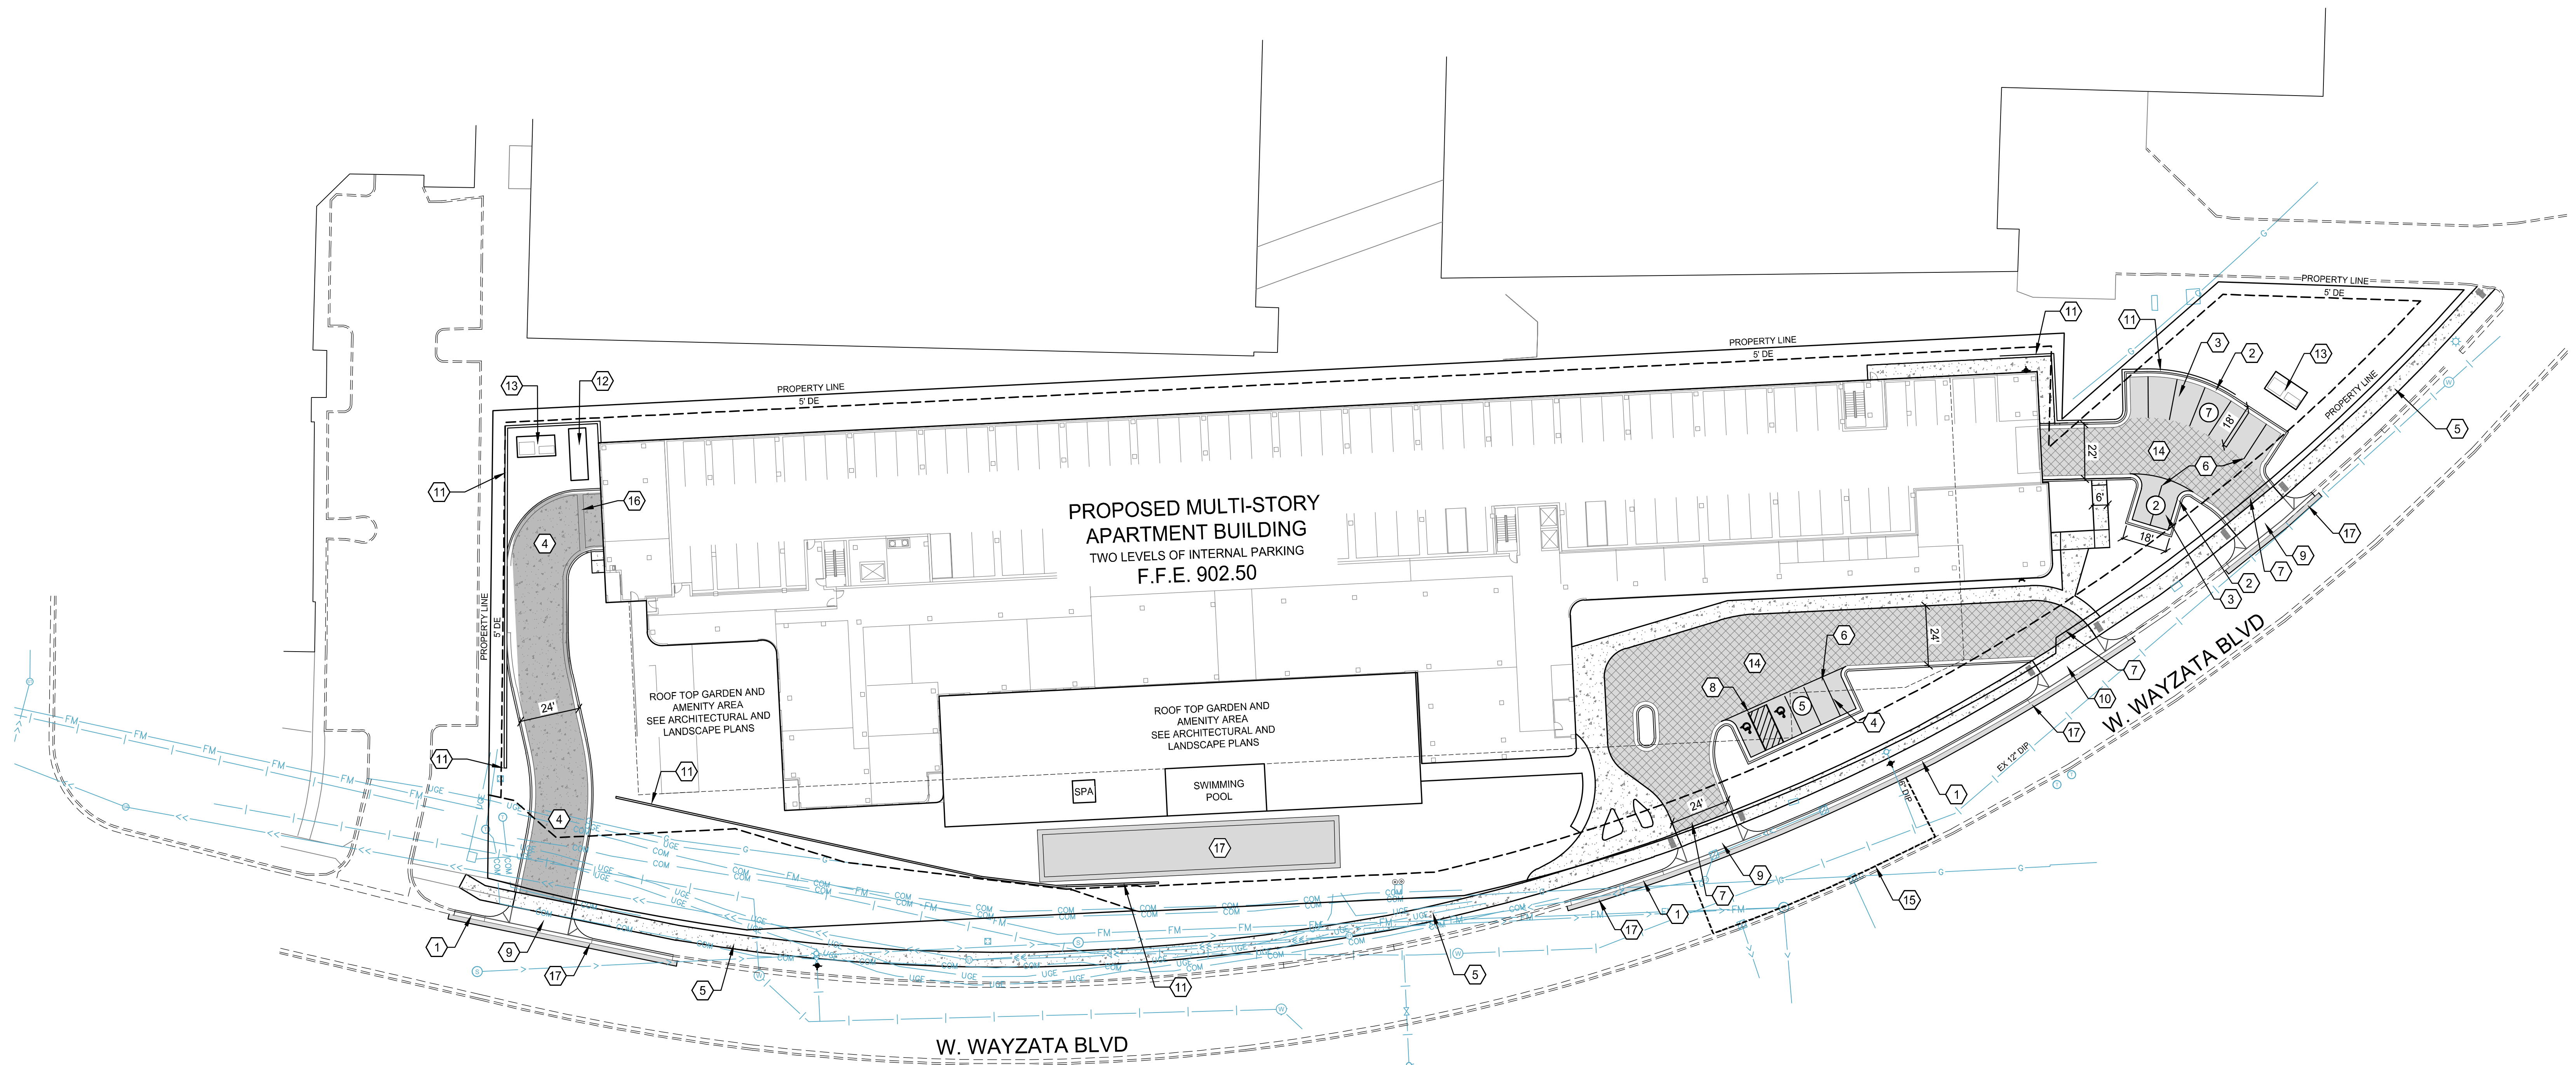

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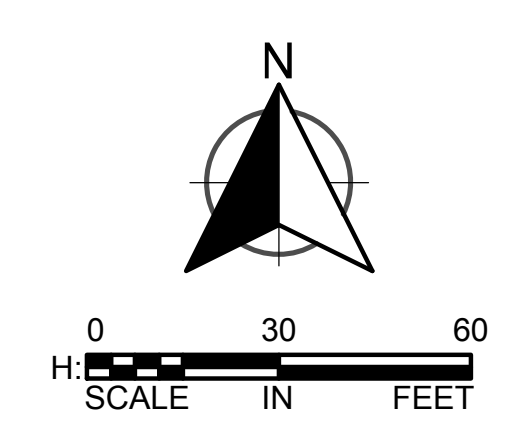
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**SITE PLAN**

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**C0.03**



TABULATION OF PROJECT AREAS	
TOTAL PROJECT AREA (BOUNDARY)	3.108 ACRES
IMPERVIOUS BEFORE DEVELOPMENT	2.300 ACRES
IMPERVIOUS AFTER DEVELOPMENT	2.258 ACRES
TOTAL DISTURBED AREA	3.509 ACRES
DEVELOPABLE AREA	3.108 ACRES

EARTHWORK	
UNADJUSTED CUT	2,010 CY
UNADJUSTED FILL	11,915 CY
NET FILL	9,905 CY


THIS IS AN ENGINEER'S ESTIMATE AND DOES NOT INCLUDE HOLD DOWNS, ANY REQUIRED SOILS CORRECTIONS. CONTRACTOR RESPONSIBLE FOR VERIFYING ACTUAL REQUIRED EARTHWORK FOR SITE.

**SITE GRADING NOTES**

- SEE SHEET C0.00 FOR CIVIL GENERAL NOTES.
- RELOCATE BENCHMARKS AS NECESSARY WITH NEW BENCHMARK LOCATIONS WITHIN A TOLERANCE OF 0.010 VERTICAL FEET.
- BUILDING FLOOR ELEVATIONS (FFE) AS INDICATED ON THESE DRAWINGS CORRESPOND TO ELEVATION 100'-0" ON ALL OTHER DISCIPLINE SHEETS (ARCHITECTURAL, STRUCTURAL, ETC).
- THE PROPOSED GRADES SHOWN ON THE GRADING PLAN ARE FINISHED GRADES. SPOT ELEVATIONS ALONG CURB LINES REPRESENT THE FLOW LINE ELEVATION OF THE CURB UNLESS OTHERWISE NOTED.
- SPOT ELEVATIONS SHOWN AT CATCH BASINS ON THIS PLAN DO NOT REFLECT 2" CASTING SUMP AND ACTUAL RIM ELEVATIONS. SEE SHEETS UTILITY PLANS FOR ACTUAL RIM ELEVATIONS.
- GRADING ACTIVITY WHICH BLOCKS TRAFFIC OF ANY STREET, ALLEY, OR DRIVE IS SUBJECT TO APPROVAL BY THE CITY OF ST. LOUIS PARK.
- CONTRACTOR SHALL STOP WORK IMMEDIATELY AND NOTIFY THE ENGINEER AND OWNER IF CONTAMINANTS ARE FOUND IN THE EXISTING SOILS.
- SIDEWALK CROSS-SLOPES SHALL NOT EXCEED 2.0% AND LONGITUDINAL SLOPES SHALL NOT EXCEED 5.0% UNLESS SPECIFICALLY NOTED HEREIN.
- IN AREAS WHERE NEW FILL IS TO BE PLACED ON SLOPING GROUND, BENCHING THE SURFACE SHALL BE COMPLETED PRIOR TO PLACING THE FILL. BENCHING SHALL BE COMPLETED WHERE SLOPES ARE STEEPER THAN 4:1 (HORIZONTAL:VERTICAL). REFER TO GEOTECHNICAL REPORT FOR ADDITIONAL INFORMATION.
- PROVIDE POSITIVE DRAINAGE AT ALL TIMES WITHIN THE CONSTRUCTION AREA. DO NOT ALLOW WATER TO POND IN EXCAVATION AREAS, AND MAINTAIN ALL EXISTING DRAINAGE PATTERNS.
- THE CONTRACTOR SHALL BE RESPONSIBLE TO COMPLY WITH ALL OSHA REGULATIONS IN THE EXECUTION OF WORK UNDER THIS CONTRACT.
- THE OWNER WILL APPLY FOR A CITY OF ST. LOUIS PARK GRADING PERMIT. THE CONTRACTOR SHALL CHECK WITH THE OWNER FOR CITY APPROVAL OF THE CITY OF ST. LOUIS PARK GRADING PERMIT BEFORE STARTING WORK. THE INSPECTOR AND THE CITY OF ST. LOUIS PARK SHALL BE NOTIFIED BY THE CONTRACTOR 48 HOURS BEFORE START OF CONSTRUCTION. NO WORK MAY BEGIN UNTIL THE PERMIT HAS BEEN RECEIVED AND THE CONTRACTOR MUST COMPLY WITH THE TERMS OF THE PERMIT.
- ALL NON-PAVED AREAS SHALL RECEIVE A FOUR-INCH (4") LAYER OF TOPSOIL. REFER TO LANDSCAPE PLANS FOR AREAS TO RECEIVE PERMANENT SEED/SOD, TREES, SHRUBS, ETC.
- THE CONTRACTOR SHALL ADJUST TO GRADE ALL MANHOLE STRUCTURES AND APPURTENANCES THAT FALL WITHIN THE LIMITS OF THIS CONTRACT. THE CONTRACTOR SHALL KEEP ALL SAID EXISTING UTILITIES AND THEIR APPURTENANCES FREE OF DEBRIS AND OPERABLE AT ALL TIMES DURING CONSTRUCTION.
- ALL GRADES WITHIN THE LANDSCAPED AREA SHALL NOT EXCEED 3 HORIZONTAL TO 1 VERTICAL UNLESS OTHERWISE NOTED.

**LEGEND**

- CL
- PROPOSED CONTOURS
- EXISTING CONTOURS
- PROPOSED SPOT ELEVATION
- EXISTING SPOT ELEVATION (MEET & MATCH EXISTING)
- GRADE BREAK
- TIP OUT CURB & GUTTER
- EXISTING WATER MAIN
- PROPOSED WATER MAIN AND SERVICES
- EXISTING HYDRANT
- PROPOSED HYDRANT
- EXISTING SANITARY SEWER PIPE
- PROPOSED SANITARY SEWER PIPE
- EXISTING SANITARY SEWER MANHOLE
- PROPOSED SANITARY SEWER MANHOLE
- EXISTING STORM SEWER PIPE
- PROPOSED STORM SEWER PIPE
- ROOF DRAINS LEADERS
- EXISTING STORM SEWER STRUCTURES
- PROPOSED STORM SEWER STRUCTURES
- PROPOSED STREET LIGHT
- EXISTING/PROPOSED UTILITY EASEMENT LINE
- SOIL BORING
- EMERGENCY OVERFLOW
- GROUND ELEV. AT TOP OF WALL
- GROUND ELEV. AT BOTTOM OF WALL
- TOP OF SIDEWALK
- EO
- TW
- BW
- TSW

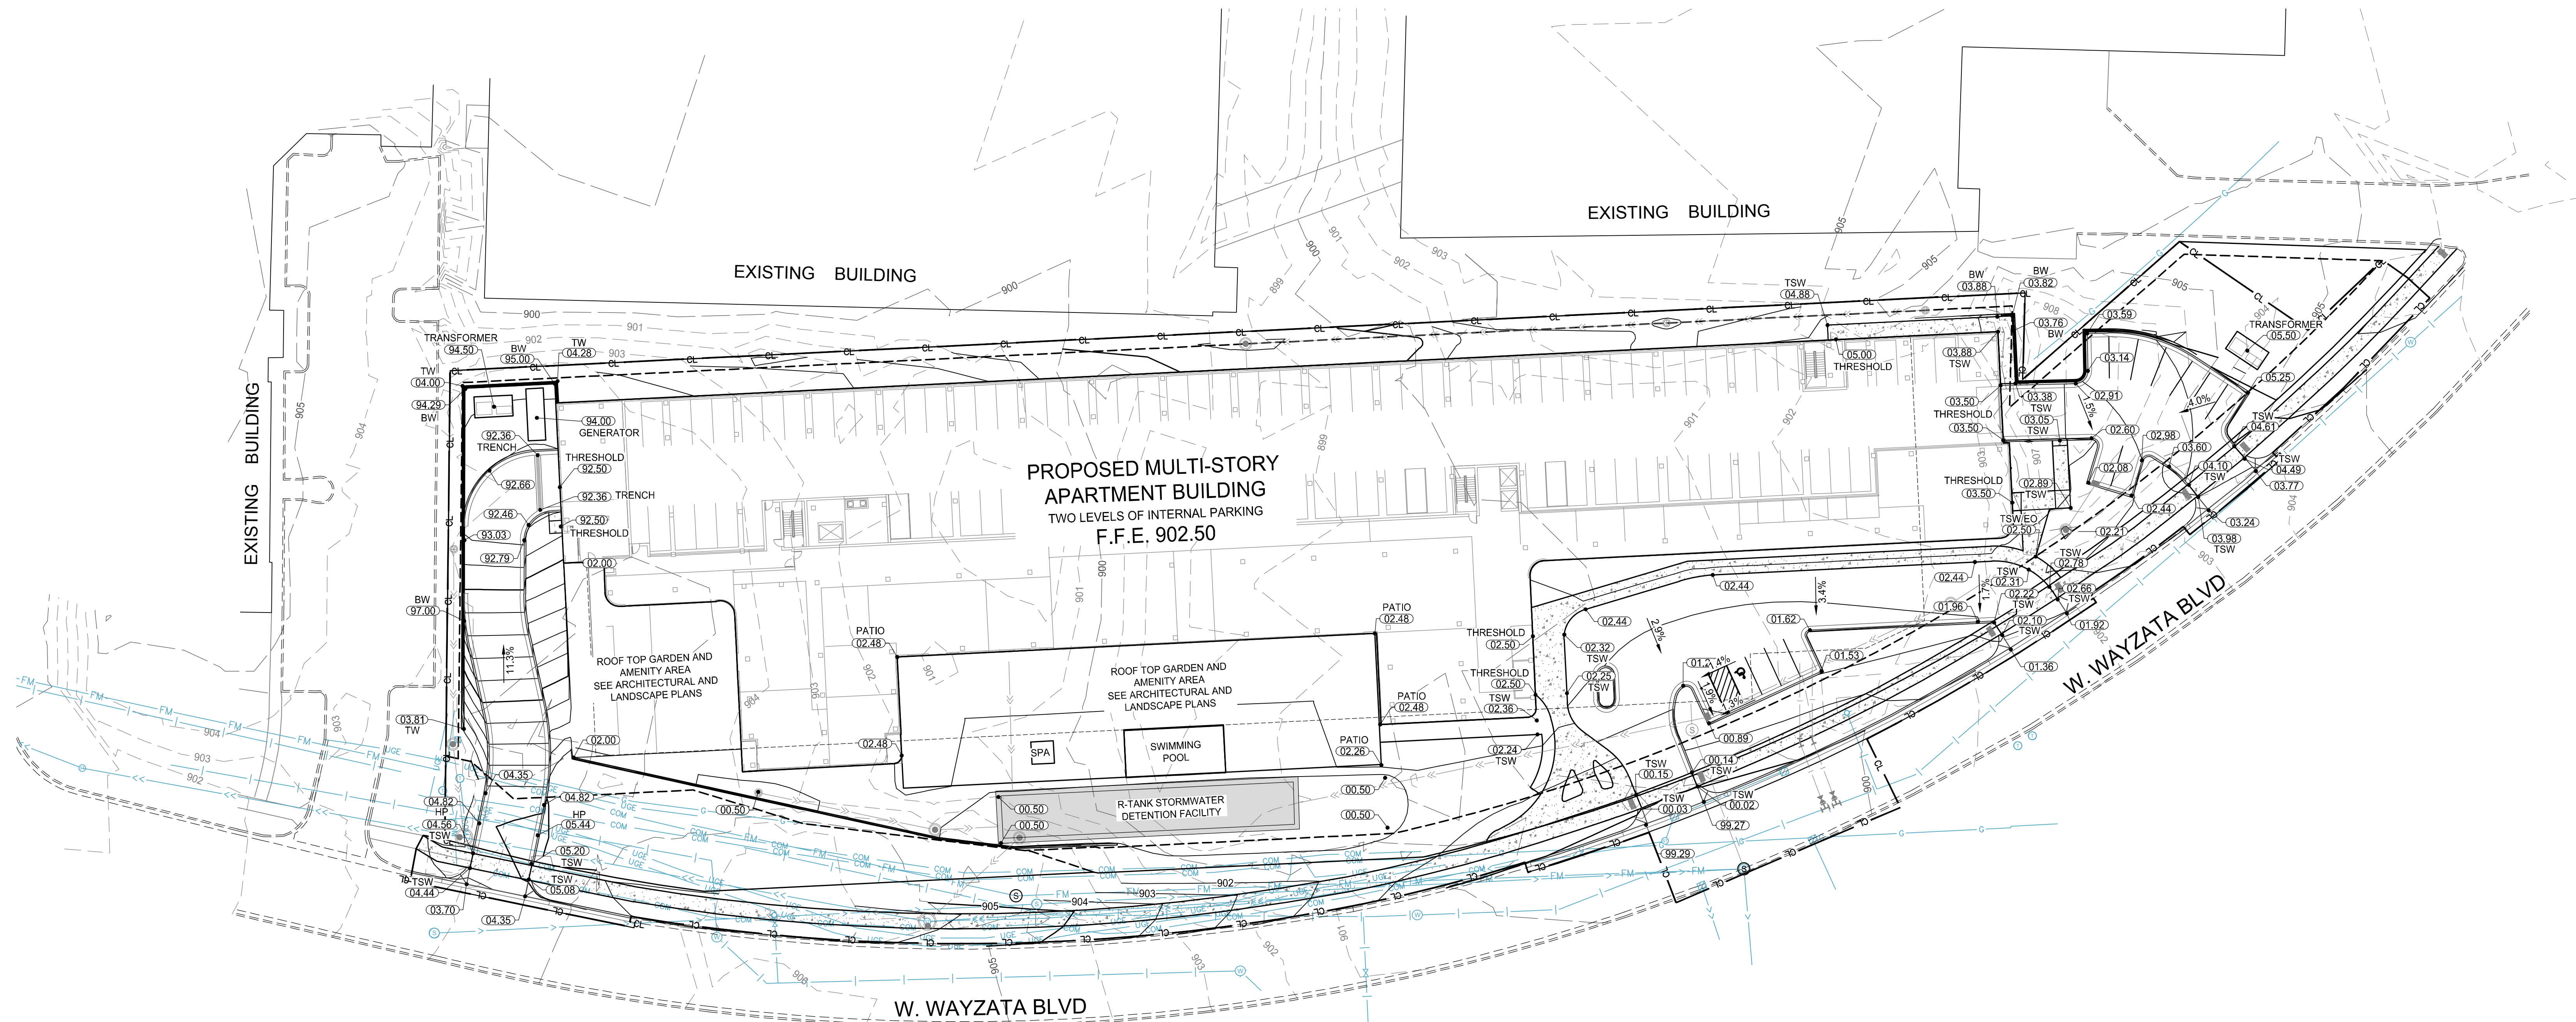

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**SEP 07 2021**


ORIGINAL ISSUE:  
 REVISIONS:  
 No. Description Date

018843-000  
 WSB PROJECT NUMBER  
 PJM CLB  
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**GRADING PLAN**

9920 Wayzata Blvd

TITLE  
**C0.07**

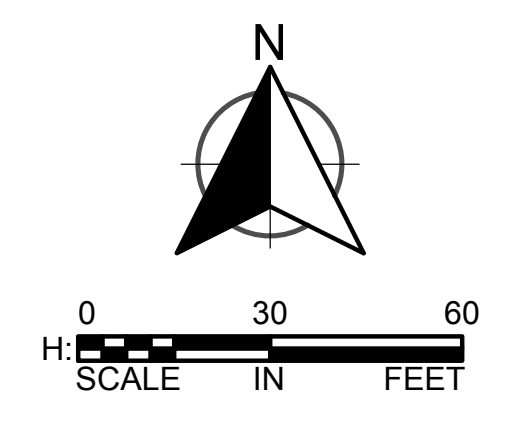

**EROSION CONTROL NOTES**


1. A STORMWATER POLLUTION PREVENTION PLAN (SWPPP) IS INCLUDED WITH THIS PROJECT. FAILURE TO IMPLEMENT THE CONTROLS AND PRACTICES OUTLINED WOULD RESULT IN VIOLATION OF THE ENVIRONMENTAL POLICY ACT AND CLEAN WATER ACT AND IS GROUNDS FOR PENALTIES.
2. ESTABLISH EROSION AND SEDIMENT CONTROL MEASURES AT THE BEGINNING OF CONSTRUCTION AND MAINTAIN DURING THE ENTIRE LENGTH OF CONSTRUCTION. AREAS WHICH ARE SUBJECT TO SEVERE EROSION AND OFF-SITE AREAS WHICH ARE ESPECIALLY VULNERABLE TO DAMAGE FROM EROSION AND/OR SEDIMENTATION ARE TO BE IDENTIFIED AND RECEIVE ADDITIONAL EROSION CONTROL AND SEDIMENT MEASURES AS DIRECTED BY THE OWNER'S CONSTRUCTION REPRESENTATIVE.
3. LOCATIONS OF STABILIZED CONSTRUCTION ENTRANCES INDICATED ON PLANS ARE APPROXIMATE. CONTRACTOR SHALL ADJUST LOCATION AND SIZE OF ENTRANCES TO ACCOMMODATE CONSTRUCTION VEHICLES AND ACTIVITIES.
4. COORDINATE ALL LAND DISTURBING ACTIVITIES AND CONDUCT SO AS TO MINIMIZE THE SIZE OF THE AREA TO BE EXPOSED AT ANY ONE TIME AND MINIMIZE THE TIME OF EXPOSURE. MASS CLEARING AND GRADING OF THE ENTIRE SITE SHOULD BE AVOIDED. COORDINATE ALL LAND DISTURBING ACTIVITIES SO AS TO MINIMIZE OFF-SITE SEDIMENTATION DAMAGE. RESTABILIZE DISTURBED AREAS AS SOON AS POSSIBLE AFTER CONSTRUCTION IS COMPLETED.
5. PERIODICALLY CLEAN OUT AND DISPOSE OF ALL SEDIMENT ONCE THE STORAGE CAPACITY OF THE DRAINAGE FEATURE OR STRUCTURE RECEIVING THE SEDIMENT IS REDUCED BY ONE-HALF. CLEAN OUT AND DISPOSE OF ALL SEDIMENT AT THE COMPLETION OF THE PROJECT. ALL STREETS IN AND ADJACENT TO THE PROJECT SHALL REMAIN CLEAN AND PASSABLE AT ALL TIMES. ANY SEDIMENT OR DEBRIS SHALL BE REMOVED WITHIN 24 HOURS, OR AS OFTEN AS NEEDED TO ENSURE PUBLIC SAFETY.
6. INLET PROTECTION WILL BE INSTALLED AT ALL CATCH BASINS WITHIN THE PROJECT AREA. THE CONTRACTOR SHALL PROVIDE APPROPRIATE EROSION CONTROL DEVICES FOR STOCKPILE AREAS, INLETS, AND DITCHES MUST BE STABILIZED WITHIN 200 LINEAL FEET FROM THE PROPERTY EDGE, OR FROM THE POINT OF DISCHARGE TO ANY SURFACE WATER. STABILIZATION MUST BE COMPLETED WITHIN 24 HOURS OF CONNECTING TO SURFACE WATER.
7. REMOVE THE TEMPORARY EROSION AND SEDIMENT CONTROL DEVICES AND VERIFY THE CLEANING OUT OF ALL STORM DRAINAGE STRUCTURES, INCLUDING FLUMES, PIPES, AND DITCHES ONCE FINAL STABILIZATION HAS OCCURRED.
8. PIPE OUTLETS NEED TEMPORARY OR PERMANENT ENERGY DISSIPATION WITHIN 24 HOURS OF GOING ONLINE.
9. WHERE GROUND WATER EXISTS, CONTRACTOR MUST SUBMIT A DEWATERING TREATMENT PLAN TO THE ENGINEER FOR APPROVAL. THE PLAN MUST INCLUDE A DEWATERING SYSTEM PRIOR TO DISCHARGING INTO RECEIVING WATER. IF DEWATERING IS REQUIRED THROUGH DISCHARGING INTO THE CITY OF ROCHESTER'S STORM SEWER SYSTEM, THE CONTRACTOR IS RESPONSIBLE FOR OBTAINING ALL NECESSARY PERMITS OR APPROVALS. THE DEWATERING PLAN MUST ENSURE THAT THE DISCHARGE WATER IS FREE OF SEDIMENT AND TURBID WATER.
10. ADDITIONAL EROSION AND SEDIMENT CONTROLS MAY BE ADDED DURING ANY PHASE OF CONSTRUCTION AS DIRECTED BY THE ENGINEER.
11. THE CONTRACTOR SHALL PROVIDE PERIMETER CONTROL DAY - TO - DAY AT DISTURBED, UNSTABILIZED AREAS WHERE EROSION OR SEDIMENTATION COULD BE A PROBLEM. THE ENGINEER SHALL DIRECT THE CONTRACTOR AS TO WHERE PLACEMENT OF PERIMETER CONTROL WILL BE REQUIRED.
12. THE CONTRACTOR MUST COMPLY WITH ALL NOISE AND DUST CONTROL ORDINANCES OF THE CITY OF ST. LOUIS PARK.
13. THE LANDSCAPE PLAN SHALL GOVERN PERMANENT EROSION OR SEDIMENT CONTROL PROVISION.
14. IF CONCRETE WASH WATER IS NOT HAULED IMMEDIATELY OFF-SITE DURING CONSTRUCTION, THE CONTRACTOR SHALL IDENTIFY AND PROVIDE A LOCATION OF A CONCRETE WASHOUT FACILITY THROUGH AN APPROVED SWPPP AMENDMENT.

TEMPORARY EROSION AND SEDIMENT CONTROL PROVISIONS	
ITEM	SCHEDULE
SILT FENCE, PERIMETER CONTROLS	PRIOR TO CONSTRUCTION AND IMMEDIATELY AS DICTATED
INLET PROTECTION	PER STANDARD DETAILS
RAPID STABILIZATION METHOD #2 (SPRING - FALL)	MNDOT TYPE 3884, HYDROMULCH AT 750 LBS PER ACRE WITHIN 7 DAYS OF CEASING WORK
RAPID STABILIZATION METHOD #2 (WINTER)	MNDOT TYPE 3882, TYPE 3 MULCH AT 1.50 TONS PER ACRE, DISC ANCHORED IN PLACE
EROSION CONTROL CATEGORY 20 (2018 VS 2020 MnDot SPEC)	WITHIN 7 DAYS OF CEASING WORK
EROSION & SEDIMENT CONTROL MAINTENANCE	WEEKLY INSPECTION & AFTER EACH RAIN EVENT-CORRECTIVE WORK AS NECESSARY

ALSO SEE INSPECTION AND MAINTENANCE REQUIREMENTS CONTAINED IN GENERAL PROVISIONS OF SWPPP.

**LEGEND**

- GEOTEXTILE DROP INLET PROTECTION. (12 EACH) (SEE DETAIL 3/C0.10)
- ROCK CONSTRUCTION EXIT. (2 EA) (SEE DETAIL 4/C0.10)
- FLOW ARROW
- SILT FENCE. (1,875 LF) (SEE DETAIL 1 & 2/C0.10)
- CONSTRUCTION LIMITS
- EXISTING WATER MAIN
- PROPOSED WATER MAIN AND SERVICES
- EXISTING HYDRANT
- PROPOSED HYDRANT
- EXISTING SANITARY SEWER PIPE
- PROPOSED SANITARY SEWER PIPE
- EXISTING SANITARY SEWER MANHOLE
- PROPOSED SANITARY SEWER MANHOLE
- EXISTING STORM SEWER PIPE
- PROPOSED STORM SEWER PIPE
- ROOF DRAINS LEADERS
- EXISTING STORM SEWER STRUCTURES
- PROPOSED STORM SEWER STRUCTURES
- PROPOSED STREET LIGHT
- EXISTING/PROPOSED UTILITY EASEMENT LINE
- SOIL BORING

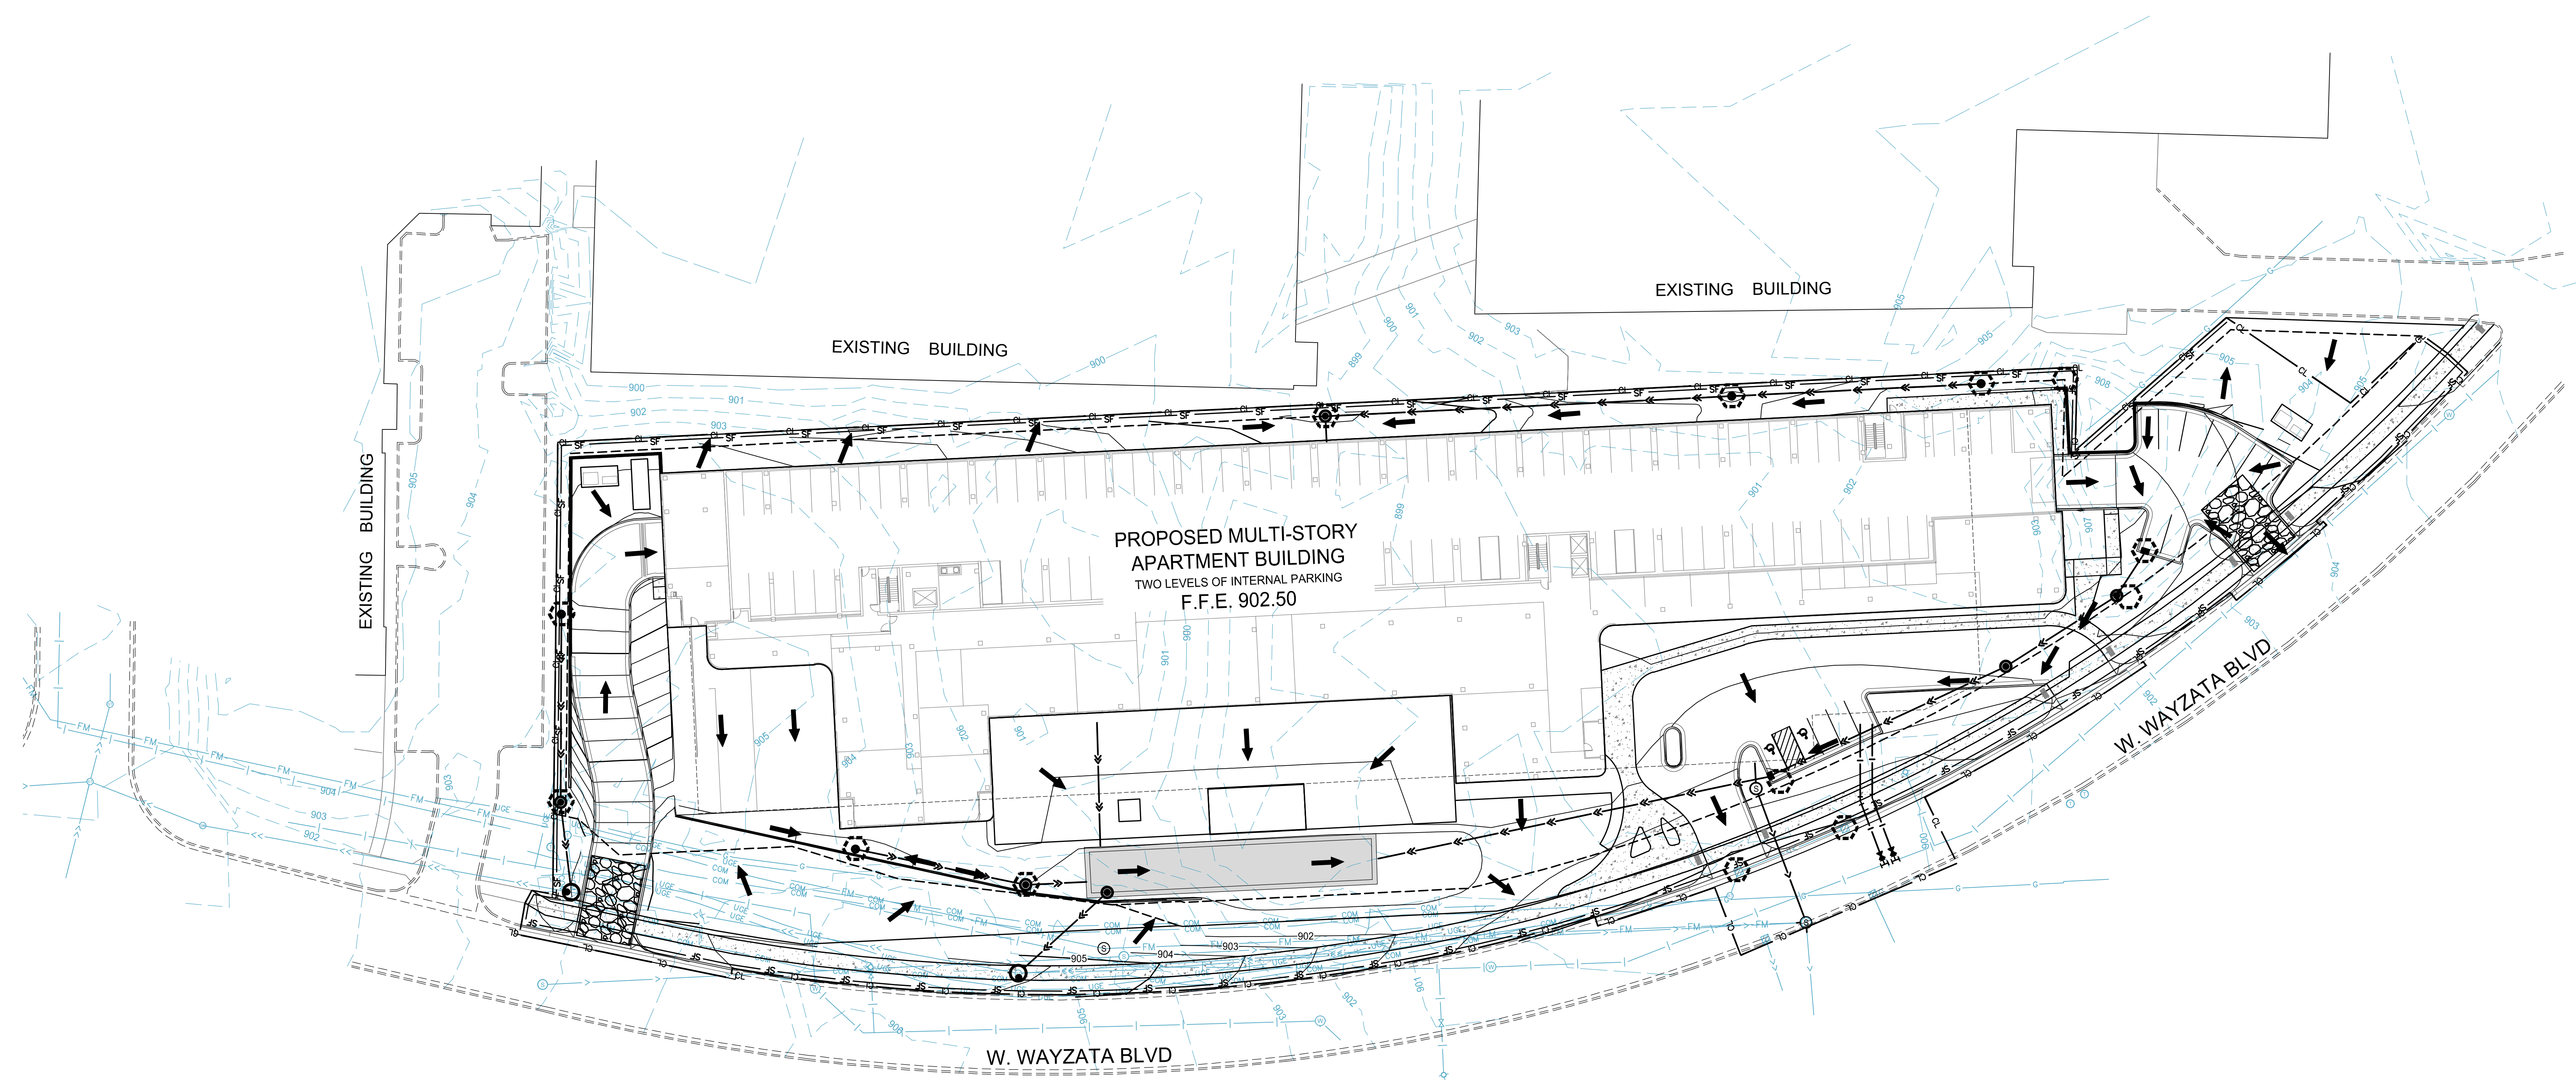

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**NOT FOR CONSTRUCTION**

PUD APPLICATION  
-  
SEP 07 2021


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**EROSION CONTROL**

9920 Wayzata Blvd

TITLE  
**C0.08**



NOT FOR CONSTRUCTION

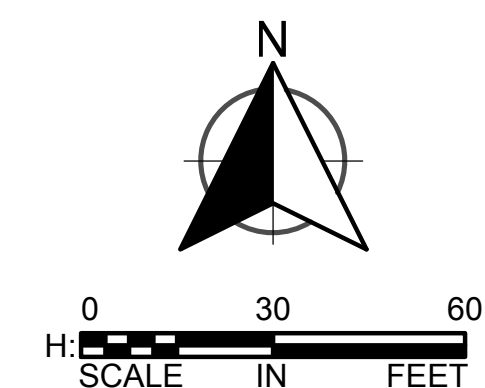
**STORMWATER POLLUTION PREVENTION PLAN (SWPPP) NARRATIVE**

**PROJECT NAME:** 9920 WAYZATA BLVD  
**PROJECT LOCATION:** STREET: WAYZATA BLVD  
CITY: ST. LOUIS PARK  
STATE: MINNESOTA  
ZIP: 55426  
**PROJECT NUMBER:** WSB 018843-000  
**COUNTY:** HENNEPIN  
**LATITUDE/LONGITUDE:** 44.9740 / -93.4044

**THE PLANNED SCOPE OF THE PROJECT INCLUDES:**  
THE PROJECT INVOLVES DEMOLITION, GRADING, UNDERGROUND UTILITIES AND CONSTRUCTION OF A MULTI-FAMILY RESIDENTIAL FACILITY WITH ASSOCIATED INFRASTRUCTURE LOCATED IN WAYZATA, MINNESOTA.

CONSTRUCTION ACTIVITIES	ESTIMATED DATES OF SOIL DISTURBANCE ACTIVITIES
TEMPORARY SEDIMENT CONTROL BMPs	OCTOBER 2021 - NOVEMBER 2021
DEMOLITION & REMOVALS	OCTOBER 2021 - NOVEMBER 2021
GRADING & UTILITY WORK	OCTOBER 2021 - JUNE 2022
BUILDING CONSTRUCTION	NOVEMBER 2021 - OCTOBER 2022
CURB & PAVEMENT	SEPTEMBER 2022
FINAL STABILIZATION / LANDSCAPING	OCTOBER 2022

**PROJECT PERSONNEL AND TRAINING**  
SEPP DEVELOPER:  
WEB (MICHAEL NASH)  
3713 4TH AVENUE NORTHWEST, SUITE 100  
ROCHESTER, MN 55901  
507.211.3384/6048@WEBENG.COM

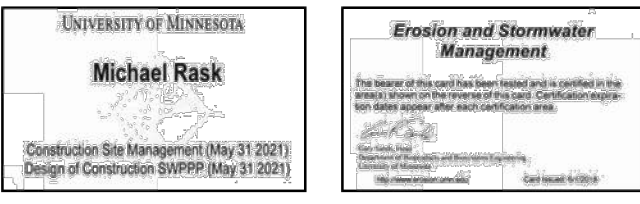

CONTRACTOR TO PROVIDE CERTIFICATION OF EROSION CONTROL OFFICER AND ANY OTHER CREW MEMBERS WHO WILL WORK ON THE IMPLEMENTATION OF THE SWPPP AND THE INSTALLATION, INSPECTION, AND MAINTENANCE OF THE EROSION PREVENTION AND SEDIMENT CONTROL BMPs BEFORE, DURING, AND AFTER CONSTRUCTION UNTIL THE NOTICE OF TERMINATION (NOTI) HAS BEEN FILLED WITH THE MPCA. PROVIDE PROOF OF CERTIFICATION AT THE PRECONSTRUCTION MEETING. WORK WILL NOT BE ALLOWED TO COMMENCE UNTIL PROOF OF CERTIFICATION HAS BEEN PROVIDED TO THE PROJECT ENGINEER.

**CHAIN OF RESPONSIBILITY**

ROLE	NAME	TITLE	PHONE
CONTRACTOR TO COMPLETE			

**AGENCY CONTACTS**

AGENCY/REGULATION	CONTACT NAME	PHONE
MPCA (IMPACT) 24 HOUR	STATE DUTY OFFICER	1-800-422-0798
MPCA	BRIAN GREEN	507-206-2610
NR	N/A	N/A
ACR	N/A	N/A
BAKESSET CREW WHO	LAURA JESTER	952-270-1990

**LOCATION OF SWPPP REQUIREMENTS**

PROJECT MANUAL, MNDOT SPEC BOOK, OR ON FILE WITH THE PROJECT OWNER.	LOCATION
DISSEMINATED	SHEET NO. C0-08
DIRECTION OF FLOW	SHEET NO. C0-08
CONSTRUCTION NOTES & STANDARD PLATES	SHEET NO. C0-10
DRAINAGE PLAN & CONSTRUCTION PLAN	SHEET NO. C0-07
EMB EROSION CONTROL	SHEET NO. C0-08
STORMWATER CALCULATIONS	HYDRAULIC REPORT, AVAILABLE UPON REQUEST

**RECEIVING WATERS**  
A SPECIAL AND IMPAIRED WATERS SEARCH WAS COMPLETED USING THE MPCA SEARCH ENGINE ON 01/04/2021. BASED ON THIS REVIEW, THE FOLLOWING SPECIAL/IMPAIRED WATERS (WITH CONSTRUCTION RELATED IMPAIRMENTS) ARE LOCATED WITHIN OUR WIDE OF, AND DOWNSTREAM OF, ANY PROJECT DISCHARGE POINTS. PARTS 23.9 & 23.10 OF THE NPDES PERMIT APPLY.

WATERBODY	IMPAIRMENT(S)
BAKESSET CREEK	FECAL COLIFORM, CHLORIDE, FISH BIOMASS/ASSESSMENTS

**AREAS OF ENVIRONMENTAL SENSITIVITY (AES) AND INFESTED WATERS**  
IN ADDITION TO THE LIST OF SPECIAL AND IMPAIRED WATERS, THERE IS A MAP OF KNOWN NATURAL RESOURCES ON THE LAST PAGE OF THE SWPPP NARRATIVE. AREAS OF ENVIRONMENTAL SENSITIVITY ARE ALSO CALLED OUT ON THE PLAN SHEETS.

**SOIL TYPES**  
A PRELIMINARY GEOTECHNICAL REPORT WAS COMPLETED DURING THE DESIGN PHASE. FILL MATERIALS IS PREDOMINATING ALONG MOST OF THE SITE AND IS UNDERLAIN BY SILTS, SANDS AND CLAYS. ADDITIONAL SOIL INFORMATION CAN BE FOUND IN THE GEOTECHNICAL REPORT, LOCATED WITHIN THE PROJECT SPECIFICATIONS. SOIL CLASSIFICATIONS FOR HIGHLY ERODIBLE LAND (HEL), POTENTIALLY HIGHLY ERODIBLE LAND (PHEL), AND NOT HIGHLY ERODIBLE LAND (NHEL) SOILS CAN BE FOUND ON FIGURE 1, SWPPP RESOURCE MAP.

**ENVIRONMENTAL REVIEW**  
NO FORMAL ENVIRONMENTAL REVIEW WAS REQUIRED FOR THIS PROJECT.  
WETLANDS: THERE ARE NO WETLAND IMPACTS PROPOSED FOR THIS PROJECT.  
DRINKING WATER/WELLS: ACCORDING TO THE MOW, THE PROJECT IS LOCATED WITH A DRINKING WATER SUPPLY MANAGEMENT AREA (OWMA) WITH MODERATE VULNERABILITY; WITHIN THE SAINT LOUIS PARK NW WELLSHAED PROTECTION AREA; AND WITHIN AN EMERGENCY RESPONSE AREA, OR NEAR ANY WELLSHAED PROTECTION AREA.

**CONTAMINATED PROPERTIES:** THE MPCA'S "WHAT'S IN MY NEIGHBORHOOD" DATABASE (PCA-61002.PCA.STATE.MN.US/WIN02/INDEX.HTML) WAS REVIEWED ON 01/04/2021. THE RESULTS OF THIS REVIEW SHOW TWO KNOWN LOCATIONS CONTAINING HAZARDOUS WASTE ADJACENT TO THE PROJECT LOCATION. METROPOLITAN CUSHMAN WAREHOUSE (44.9744, -93.4030) HAS BEEN IDENTIFIED AS AN INACTIVE HAZARDOUS WASTE SITE (ID #: MND05761001). IN ADDITION, GEMMA & CO. CO. LLC - ST. LOUIS PARK (44.9744, -93.4015) HAS BEEN IDENTIFIED AS AN ACTIVE HAZARDOUS WASTE SITE (ID #: MND00104811). REFER TO MNDOT SPEC 1117.1.A. FOR POTENTIAL INDICATORS OF CONTAMINATED MATERIALS AND REGULATED WATERS. IF CONTAMINATED MATERIAL, CONTAMINATED WATER, AND/OR REGULATED MATERIALS ARE FOUND, CREWS ARE TO STOP WORK IMMEDIATELY FOR FURTHER INVESTIGATION/TESTING.

**FLOOD CONTINGENCY PLAN:** PROJECT ACTIVITIES ARE NOT LOCATED WITHIN THE 100-YEAR FLOODPLAIN OR FLOODWAY. HOWEVER, THE PROJECT ENGINEER (AT THEIR DISCRETION) MAY REQUIRE A PREVENTATIVE FLOOD CONTINGENCY PLAN FOR SPECIFIC PROJECT ACTIVITIES AND AREAS IF SEASONAL PRECIPITATION POSSES A POTENTIAL RISK OF FLOODING WORK AREAS WITHIN THE PROJECT LIMITS. THIS PLAN SHALL BE SUBMITTED BY THE OPERATOR TO THE PROJECT ENGINEER FOR APPROVAL. A MINIMUM OF 72 HOURS PRIOR TO THE SCHEDULED WORK AND/OR DURING ACTIVE WORK WITHIN THE AREA OF POTENTIAL RISK OF FLOODING. NO WORK CAN COMMENCE IN THE AREA UNTIL WRITTEN APPROVAL HAS BEEN GRANTED BY THE PROJECT ENGINEER.

**LAND FEATURE CHANGES**  
TOTAL AREA TO BE DISTURBED = 3.31 ACRES  
IMPERVIOUS AREA: PRE-CONSTRUCTION = 2.30 ACRES/POST-CONSTRUCTION = 2.26 ACRES  
NET INCREASE OF IMPERVIOUS AREA = -0.04 ACRES

**LONG TERM MAINTENANCE AND OPERATION:**  
THE NPDES PERMANENT WATER QUALITY VOLUME (PART 15.1) FROM THE NET NEW IMPERVIOUS SURFACES OF THE PROJECT IS NOT TRIGGERED FOR THIS PROJECT AS A NET REDUCTION IN IMPERVIOUS SURFACE IS PROPOSED; HOWEVER, PERMANENT STORMWATER MANAGEMENT WILL BE ADDRESSED USING AN UNDERGROUND STORMWATER STORAGE FACILITY. HYDROLOGIC AND WATER QUALITY MODELING DATA IS AVAILABLE UPON REQUEST.

**STABILIZATION TIME FRAMES**

AREA	TIME FRAME	NOTES
EXPOSED AREAS	IMMEDIATELY AND NO LATER THAN 1 DAY OF BEING UNWORKED	1, 4, 3
LAST 200 LINEAL FEET OF DRAINAGE DITCH/SWALE	WITHIN 24 HOURS OF CONNECTION TO SURFACE WATER/PROPERTY	1, 2, 3
EDGE		1, 3
REMAINING PORTIONS OF DRAINAGE DITCH OR SWALE	7 DAYS	1, 3
PIPE AND CULVERT OUTLETS	24 HOURS	1
STOCKPILES	7 DAYS	1

- INITIATE STABILIZATION IMMEDIATELY WHEN CONSTRUCTION HAS TEMPORARILY OR PERMANENTLY CEASED ON ANY PORTION OF THE SITE. COMPLETE STABILIZATION WITHIN THE TIME FRAME LISTED. IN MANY INSTANCES THIS WILL REQUIRE STABILIZATION TO OCCUR MORE THAN ONCE DURING THE COURSE OF THE PROJECT. TEMPORARY SOIL STOCKPILES WITHOUT SIGNIFICANT CLAY OR SILT AND STOCKPILES AND CONSTRUCTED ROAD BASE ARE EXEMPT FROM THE STABILIZATION REQUIREMENT.
- STABILIZE WETTED PERIMETER OF DITCH (I.E. WHERE THE DITCH GETS WET)
- APPLICATION OF MULCH, HYDROMULCH, SODDIFIER AND POLYACRYLAMIDE ARE NOT ACCEPTABLE STABILIZATION METHODS IN THESE AREAS.
- STABILIZE ALL AREAS OF THE SITE PRIOR TO THE ONSET OF WINTER. ANY WORK STILL BEING PERFORMED WILL BE MULCHED OR BLANKETTED WITHIN THE TIME FRAMES IN THE NPDES PERMIT.
- KEEP DITCHES AND EXPOSED SOILS IN AN EVEN ROUGH GRADED CONDITION IN ORDER TO BE ABLE TO APPLY EROSION CONTROL MULCHES, HYDROMULCHES, AND SODDIFIERS.


**SITE INSPECTION AND MAINTENANCE**  
THE EROSION CONTROL OFFICER IS TO INSPECT THE ENTIRE CONSTRUCTION SITE AT LEAST ONCE EVERY SEVEN (7) DAYS DURING ACTIVE CONSTRUCTION AND WITHIN 24 HOURS AFTER A RAINFALL EVENT GREATER THAN 0.5 INCHES IN 24 HOURS. THE OPERATOR SHALL PROVIDE A RAINFALL GAUGE ON-SITE AT VARIOUS MILE INTERVALS ALONG THE ALIGNMENT. INSPECT ALL TEMPORARY AND PERMANENT CONTROL BMPs UNTIL THE SITE HAS UNDERGONE FINAL STABILIZATION AND THE NOT HAS BEEN SUBMITTED. INSPECT SURFACE WATER INCLUDING DRAINAGE DITCHES FOR SIGNS OF EROSION AND SEDIMENT DEPOSITION. INSPECT CONSTRUCTION SITE VEHICLE EXIT LOCATIONS FOR EVIDENCE OF TRACKING ONTO PAVED SURFACES. INSPECT SURROUNDING PROPERTIES FOR EVIDENCE OF OFF-SITE SEDIMENT ACCUMULATION. ALL INSPECTIONS AND MAINTENANCE CONDUCTED MUST BE RECORDED IN WRITING BY THE OPERATOR AND RETAINED WITH THE SWPPP. SUBMIT INSPECTION REPORTS IN A FORMAT THAT IS ACCEPTABLE TO THE PROJECT ENGINEER. RECORDS OF EACH INSPECTION AND MAINTENANCE ACTIVITY SHALL INCLUDE:  
A. DATE, TIME, AND NAME OF PERSON(S) CONDUCTING INSPECTIONS;

- FINDINGS OF INSPECTIONS, INCLUDING RECOMMENDATIONS FOR CORRECTIVE ACTIONS;
- CORRECTIVE ACTIONS TAKEN (INCLUDING DATES, TIMES, AND PARTY COMPLETING MAINTENANCE ACTIVITIES); INCLUDING DOCUMENTATION/PHOTOS OF IMPLEMENTED BMPs INTENDED TO CORRECT A PROBLEMS BUT FAILED.
- DATE AND AMOUNT OF ALL RAINFALL EVENTS GREATER THAN 0.5 INCHES IN 24 HOURS;
- DOCUMENTATION OF CHANGES MADE TO THE SWPPP.


- REPAIR, REPLACE, OR SUPPLEMENT ALL NONFUNCTIONAL BMPs BY THE END OF THE NEXT BUSINESS DAY FOLLOWING DISCOVERY UNLESS LISTED DIFFERENTLY BELOW:
- REPAIR, REPLACE, OR SUPPLEMENT PERIMETER CONTROL DEVICES WHEN THEY BECOME NONFUNCTIONAL OR SEDIMENT REACHES 1/2 THE HEIGHT OF THE DEVICE. CORRECTIVE REPAIRS BY THE END OF THE NEXT BUSINESS DAY FOLLOWING DISCOVERY.
- REMOVE ALL DELTA AND SEDIMENT DEPOSITED IN SURFACE WATERS INCLUDING DRAINAGE WAYS, CATCH BASINS, AND OTHER DRAINAGE SYSTEMS. STABILIZE ANY AREAS THAT ARE DISTURBED BY SEDIMENT REMOVAL OPERATIONS. SEDIMENT REMOVAL AND STABILIZATION MUST BE COMPLETED WITHIN 7 DAYS OF DISCOVERY.
- REMOVE TRACKED SEDIMENT FROM PAVED SURFACES BOTH ON AND OFF SITE WITHIN ONE (1) CALENDAR DAY OF DISCOVERY. STREET SNEEYING MAY HAVE TO OCCUR MORE OFTEN TO MINIMIZE OFF SITE IMPACTS. LIGHTLY WET THE PAVEMENT PRIOR TO SNEEYING.
- MAINTAIN ALL BMPs UNTIL WORK HAS BEEN COMPLETED, SITE HAS GONE UNDER FINAL STABILIZATION, AND THE NOT HAS BEEN SUBMITTED TO THE MPCA.

**CONSTRUCTION ACTIVITY REQUIREMENTS: EROSION/SEDIMENT CONTROL, PROCEDURES, & MAINTENANCE STANDARDS**


- AMEND THE SWPPP AND DOCUMENT ALL CHANGES TO THE SWPPP AND ASSOCIATED PLAN SHEETS IN A TIMELY MANNER. SWPPP AMENDMENTS AND SITE PLANS WILL BE PREPARED BY THE OPERATOR AND SUBMITTED TO THE OWNER FOR REVIEW AND WRITTEN APPROVAL BY THE PROJECT OWNER (OR DESIGNATED REPRESENTATIVE). STORE THE SWPPP AND ALL AMENDMENTS ON SITE AT ALL TIMES.
- PREPARE AND SUBMIT A SITE MANAGEMENT PLAN FOR THE ENGINEER'S ACCEPTANCE FOR STAGING/STOCKPILE MANAGEMENT AREAS, CONCRETE MANAGEMENT, POSITIVE DIRT CONTROL PLAN, SPILL CONTAINMENT PLAN, AREAS IDENTIFIED IN THE PLANS AS "SITE MANAGEMENT PLAN AREA". ANY WORK THAT WILL REQUIRE DEMARKING, ANY ADDITIONAL PLANS LISTED IN THE PROJECT SPECIFICATIONS, AND AS REQUIRED BY THE ENGINEER. SUBMIT ALL SITE MANAGEMENT PLANS TO THE ENGINEER IN WRITING. ALLOW A MINIMUM OF 7 DAYS FOR THE PROJECT ENGINEER TO REVIEW AND ACCEPT SITE MANAGEMENT PLAN SUBMITTALS. WORK WILL NOT BE ALLOWED TO COMMENCE IF A SITE MANAGEMENT PLAN IS REQUIRED UNTIL ACCEPTANCE HAS BEEN GRANTED BY THE ENGINEER. THERE WILL BE NO EXTRA TIME ADDED TO THE CONTRACT DUE TO THE UNEXPECTED SUBMITTALS.
- THERE IS NO CONSTRUCTION STAGING OR STAGING DEFINED BY THE OWNER FOR THIS PROJECT. THE SCHEDULE FOR INSTALLING TEMPORARY BMPs SHALL BE INCORPORATED INTO THE OPERATOR'S WEEKLY SCHEDULE FOR EACH CONSTRUCTION STAGE AND PRESENTED TO THE OWNER'S REPRESENTATIVE.
- BURNING OF ANY MATERIALS IS NOT ALLOWED WITHIN PROJECT BOUNDARIES.
- DO NOT DISTURB AREAS OUTSIDE OF THE CONSTRUCTION LIMITS. DELINEATE AREAS NOT TO BE DISTURBED AND WETLANDS (EVEN AREAS THAT ARE PERMITTED FOR CONSTRUCTION) PRIOR TO STARTING GROUND DISTURBING ACTIVITIES. IF IT BECOMES NECESSARY TO DISTURB AREAS OUTSIDE OF THE CONSTRUCTION LIMITS, OBTAIN WRITTEN PERMISSION FROM THE PROJECT ENGINEER PRIOR TO PROCEEDING. PRESERVE ALL NATURAL BUFFER ZONES ON THE PLANS.
- STOP STORMWATER AND/OR SEDIMENTATION AREAS OF THE SITE WHENEVER FEASIBLE. PROVIDE EROSION CONTROL AND VELOCITY DISSIPATION DEVICES AS NEEDED TO KEEP CHANNELS FROM ERODING AND TO PREVENT NUISANCE CONDITIONS AT THE OUTLET.
- DIRECT DISCHARGE FROM BMPs TO VEGETATED AREAS WHENEVER FEASIBLE. PROVIDE VELOCITY DISSIPATION DEVICES AS NEEDED TO PREVENT EROSION.
- LOCATE PERIMETER CONTROL OF THE CONTOUR TO CAPTURE OVERFLOW. LOW-VELOCITY SHEET FLOW DOWN GRADIENT OF ALL EXPOSED SOILS AND PRIOR TO DISCHARGING TO SURFACE WATERS. PLACE 3-INCHES AT A MAXIMUM OF 100-FOOT INTERVALS.
- ALL STOCKPILES MUST HAVE PERIMETER SEDIMENT CONTROLS IMPLEMENTED AND MAINTAINED AT ALL TIMES. PILES CANNOT BE PLACED IN BUFFER AREAS OR SURFACE WATERS, INCLUDING STORMWATER CONVEYANCES SUCH AS CURBS AND GUTTER SYSTEMS, OR CONDUITS AND DITCHES UNLESS THERE IS A BIFURC IN PLACE TO PREVENT STORMWATER RUN-ON INTO THE STOCKPILE.
- STEEP SLOPES MAY BE TEMPORARILY STABILIZED DURING OPERATIONS. STABILIZATION OF STEEP SLOPES (3% OR GREATER) SHALL BE PROPERLY CAT-TRACKED AND STABILIZED PER THE EROSION CONTROL PLAN. LONG SLOPES CAN BE BROKEN UP WITH SEDIMENT CONTROL LOGS IF EROSION IS EVIDENT.
- DITCH CHECKS WILL BE PLACED AS INDICATED ON THE PLANS DURING ALL PHASES OF CONSTRUCTION.
- ALL STORM DRAIN INLETS, THAT RECEIVE PROJECT STORMWATER, MUST BE PROTECTED BY APPROPRIATE BMPs DURING CONSTRUCTION UNTIL ALL SOURCES WITH POTENTIAL FOR DISCHARGING TO THE INLET HAVE BEEN STABILIZED. INLET PROTECTION MAY BE REMOVED FOR A PARTICULAR INLET IF A SPECIFIC SAFETY CONCERN (STREET FLOODING/FREEZING) HAS BEEN IDENTIFIED AND THE PERMITS/ISSUES HAS RECEIVED WRITTEN CORRESPONDENCE FROM THE JURISDICTIONAL AUTHORITY VERIFYING THE NEED FOR REMOVAL. WRITTEN CORRESPONDENCE MUST BE DOCUMENTED IN THE SWPPP.
- SILT FENCE IS NOT AN ACCEPTABLE CATCH BASIN INLET PROTECTION BMP. CONTRACTOR SHALL CLEAN, REMOVE AND DISPOSE OF SEDIMENT, AND/OR REPLACE STORM DRAIN INLET PROTECTION BMP. CONTRACTOR SHALL CLEAN, REMOVE AND DISPOSE OF SEDIMENT PRIOR TO THE NEXT FORECASTED PRECIPITATION EVENT 150% OR GREATER.
- DITCH CHECKS WILL BE PLACED AS INDICATED ON THE PLANS DURING ALL PHASES OF CONSTRUCTION.
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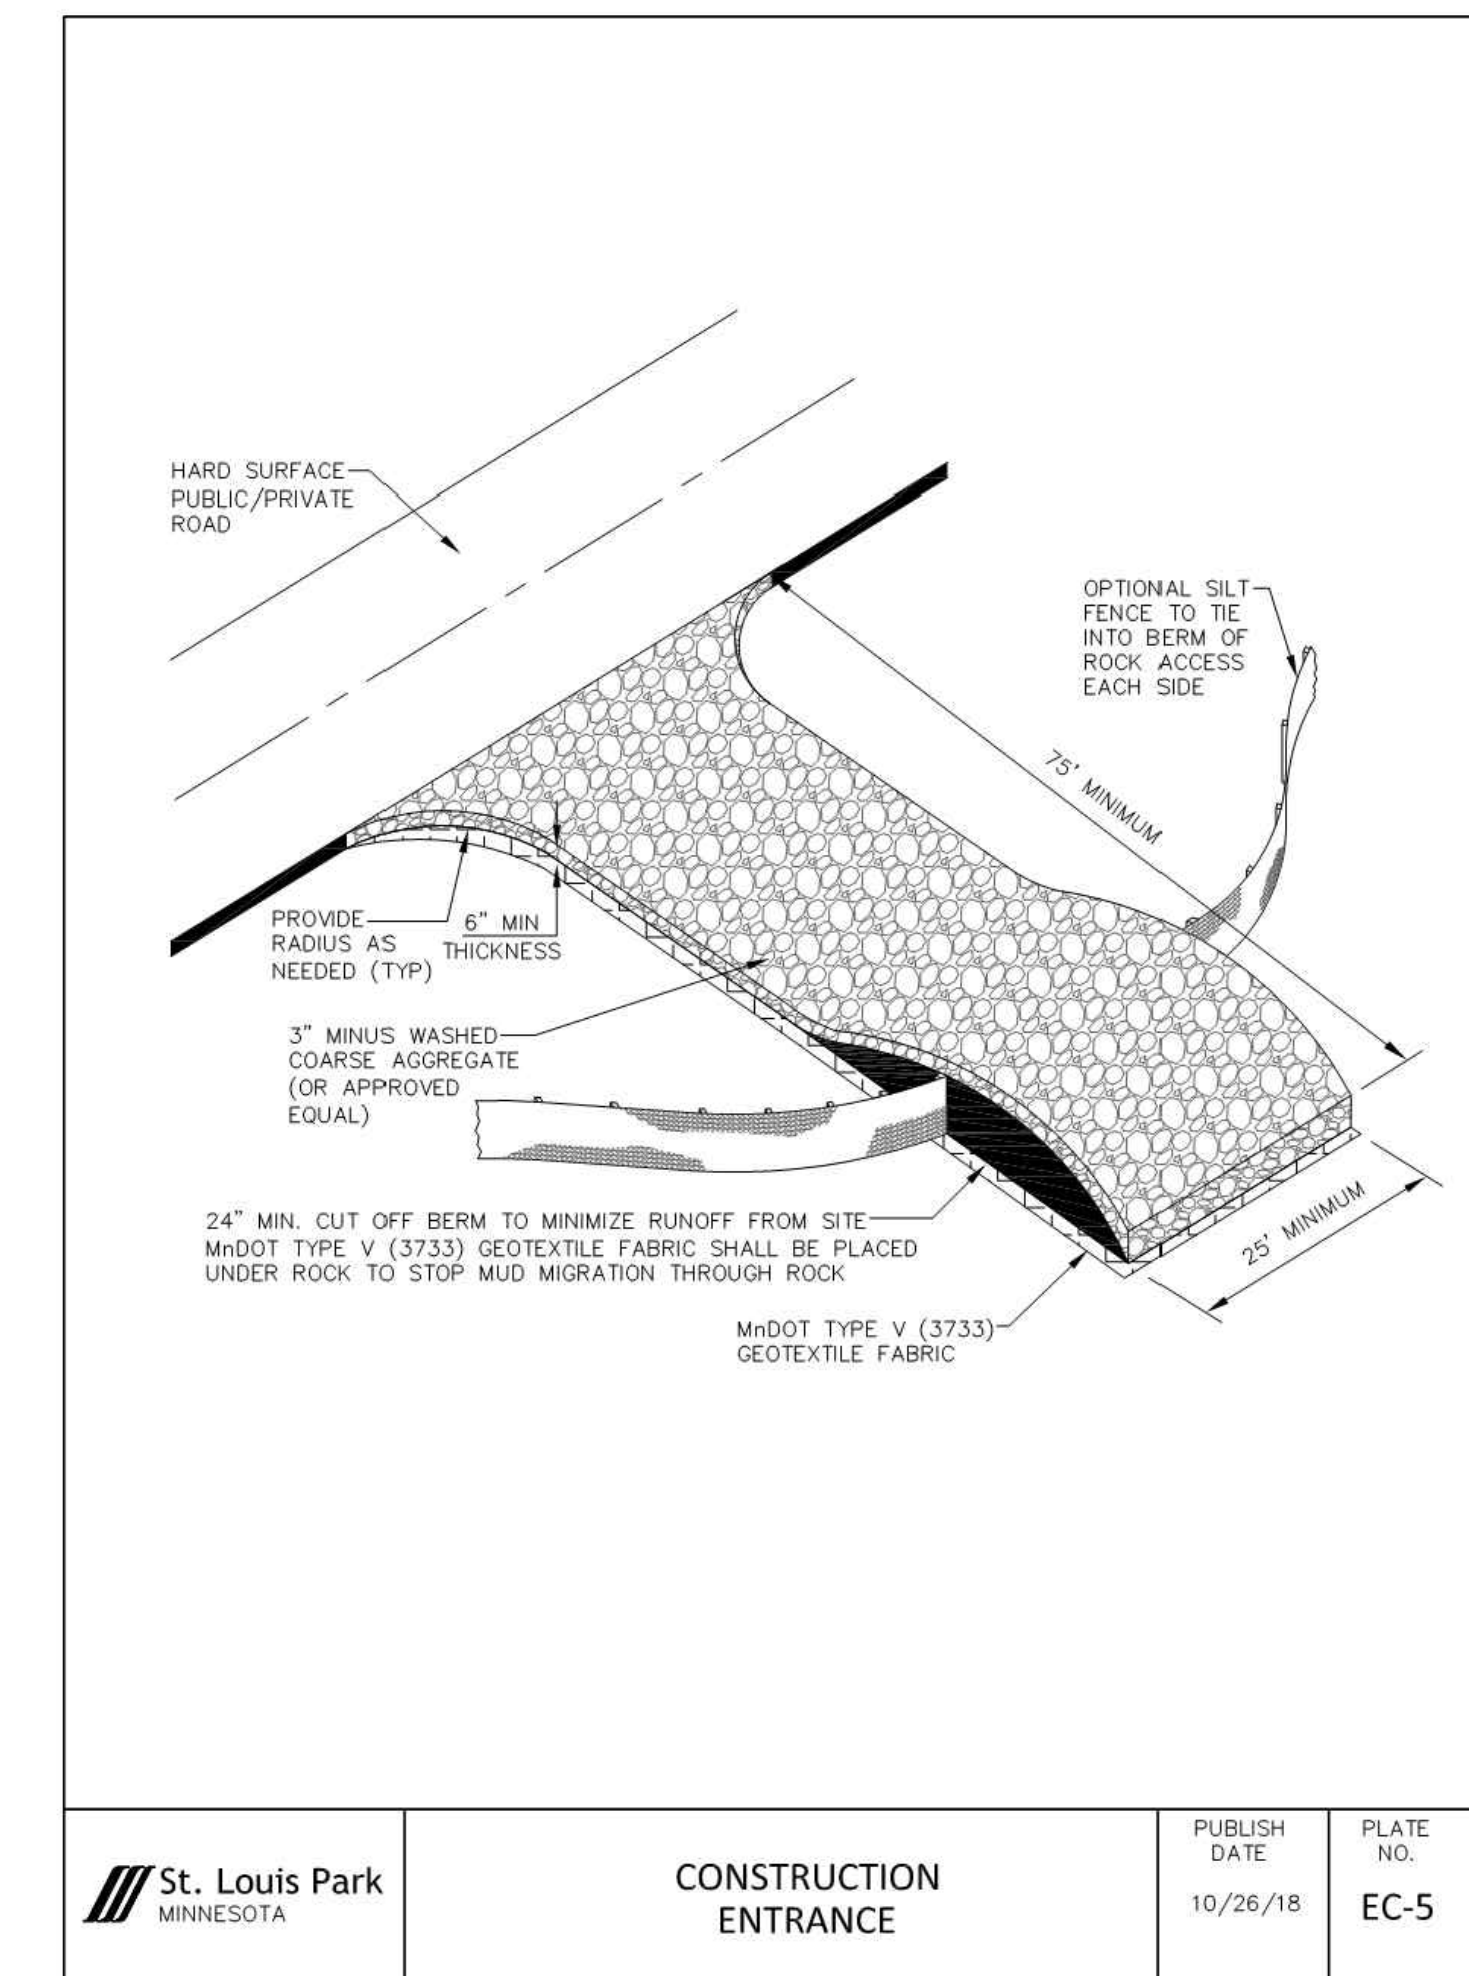
1 SILT FENCE MACHINE SLICED  
 CO.10 SCALE: NOT TO SCALE

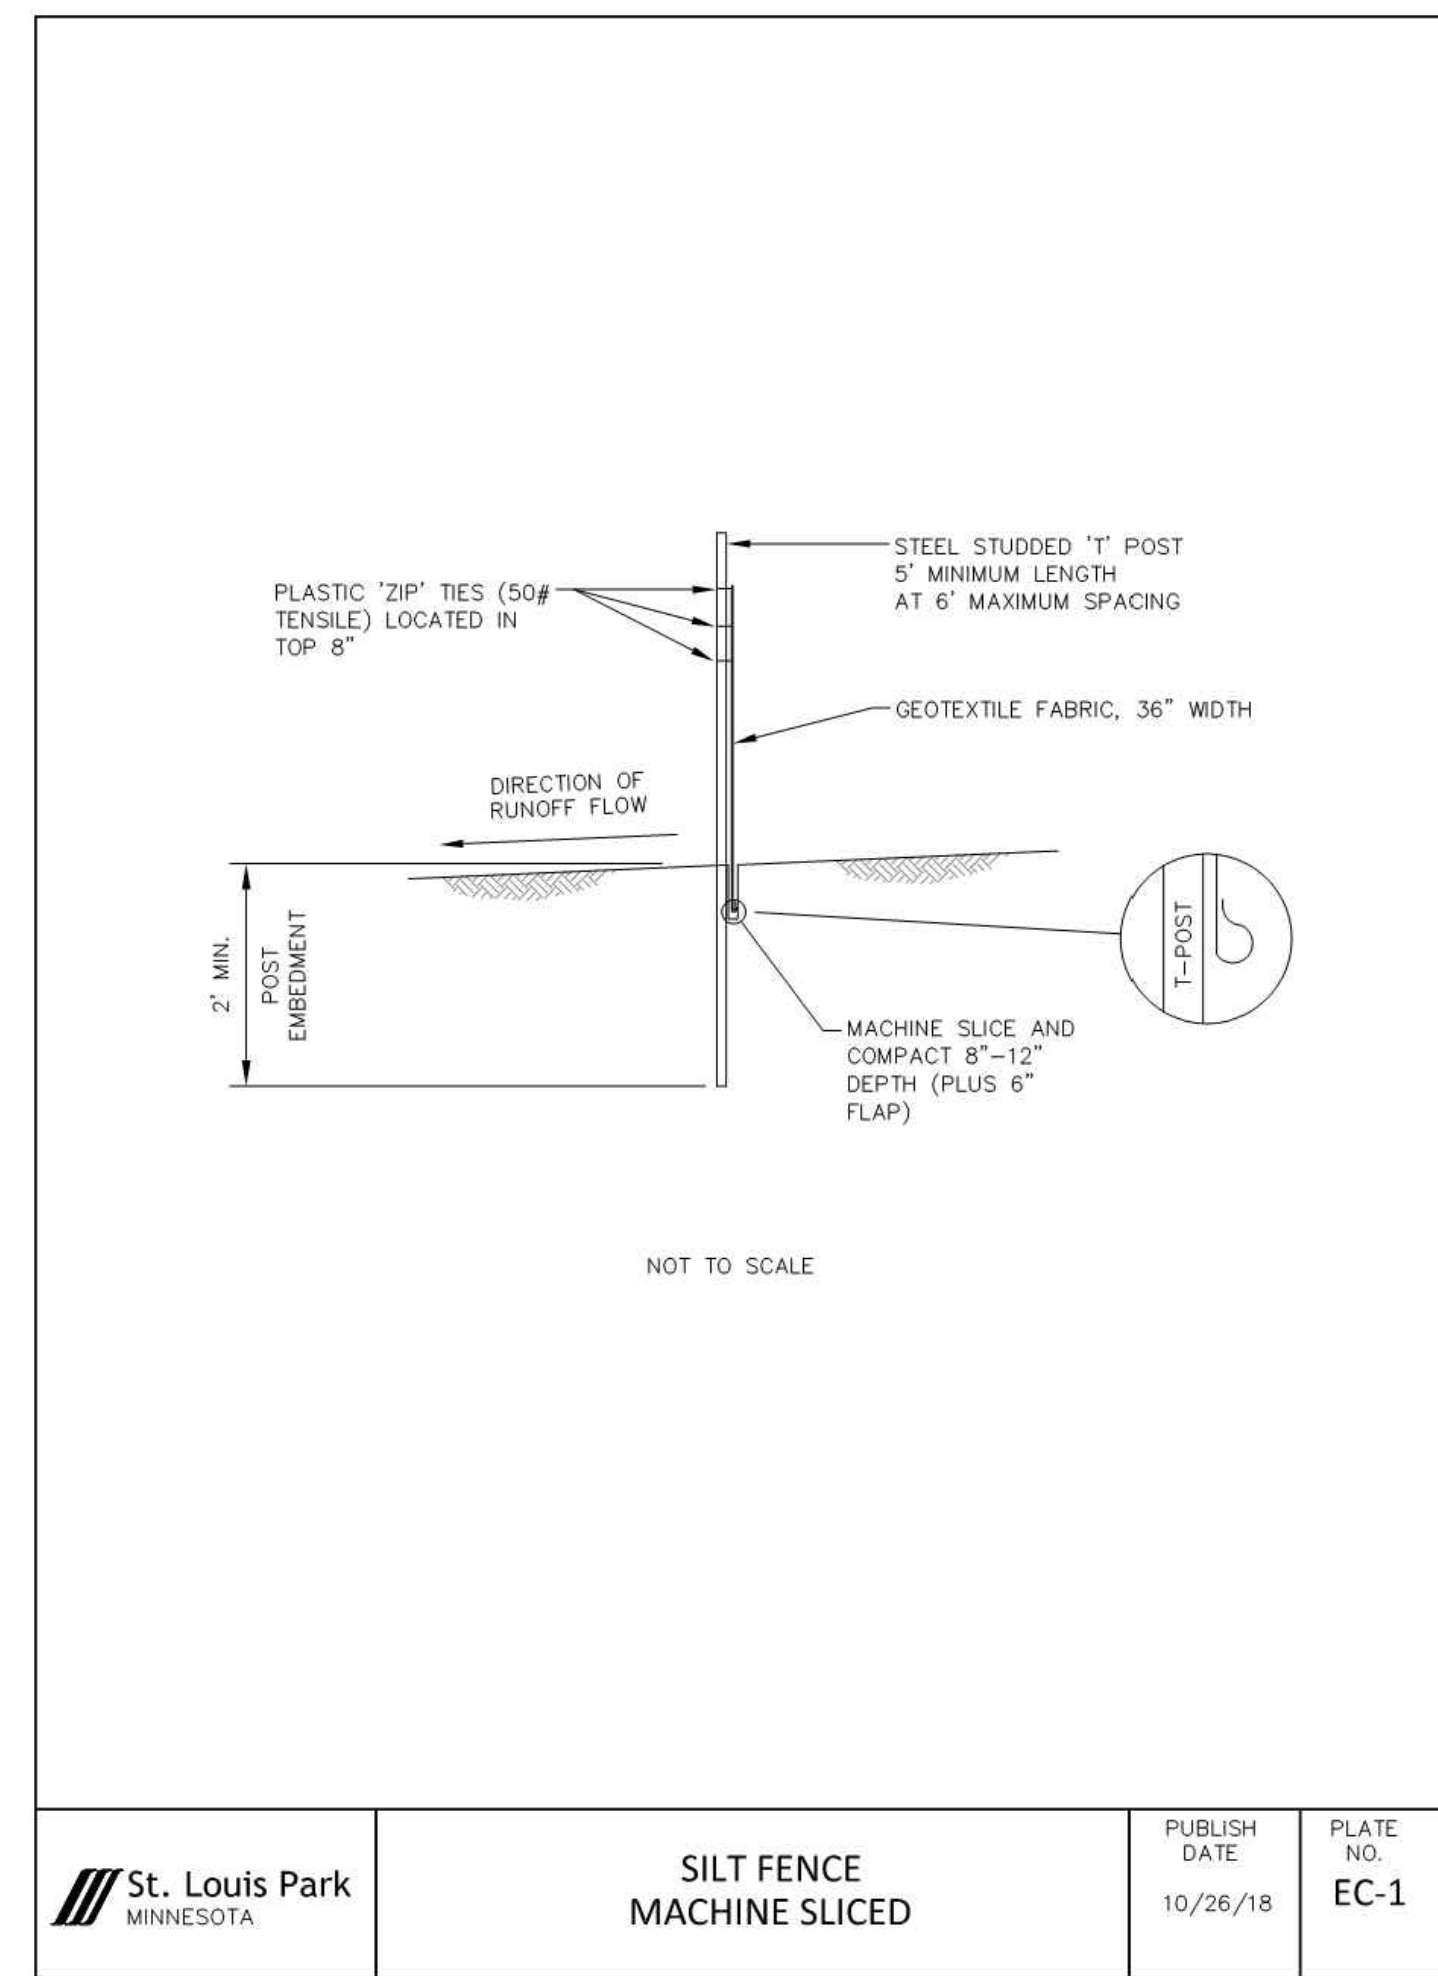

2 SILT FENCE PREASSEMBLED  
 CO.10 SCALE: NOT TO SCALE

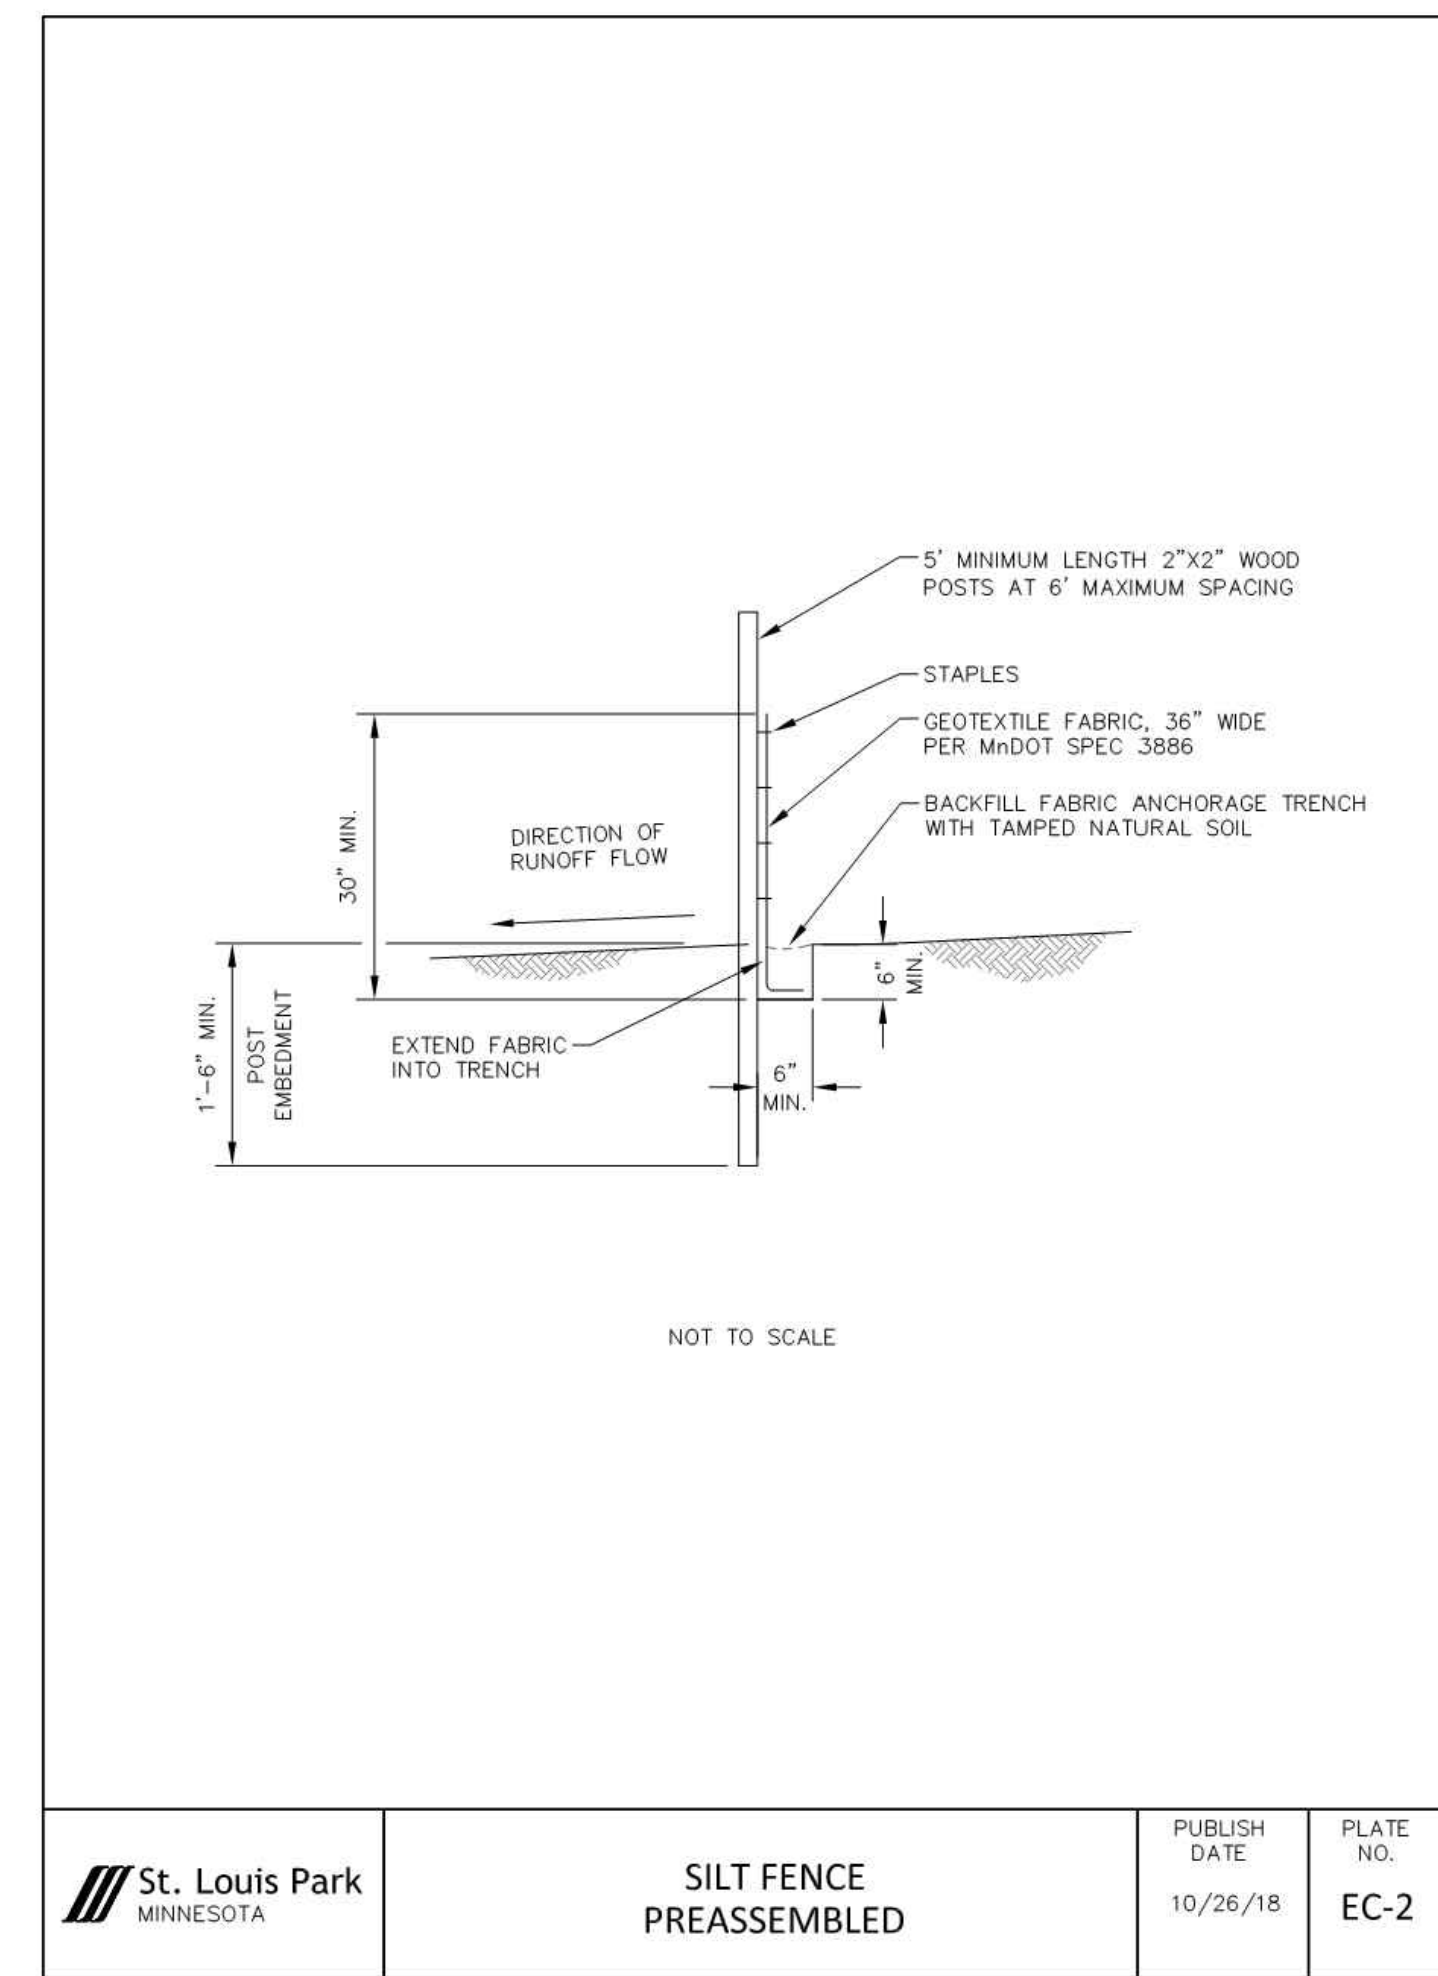

3 CATCH BASIN METAL INLET PROTECTION  
 CO.10 SCALE: NOT TO SCALE

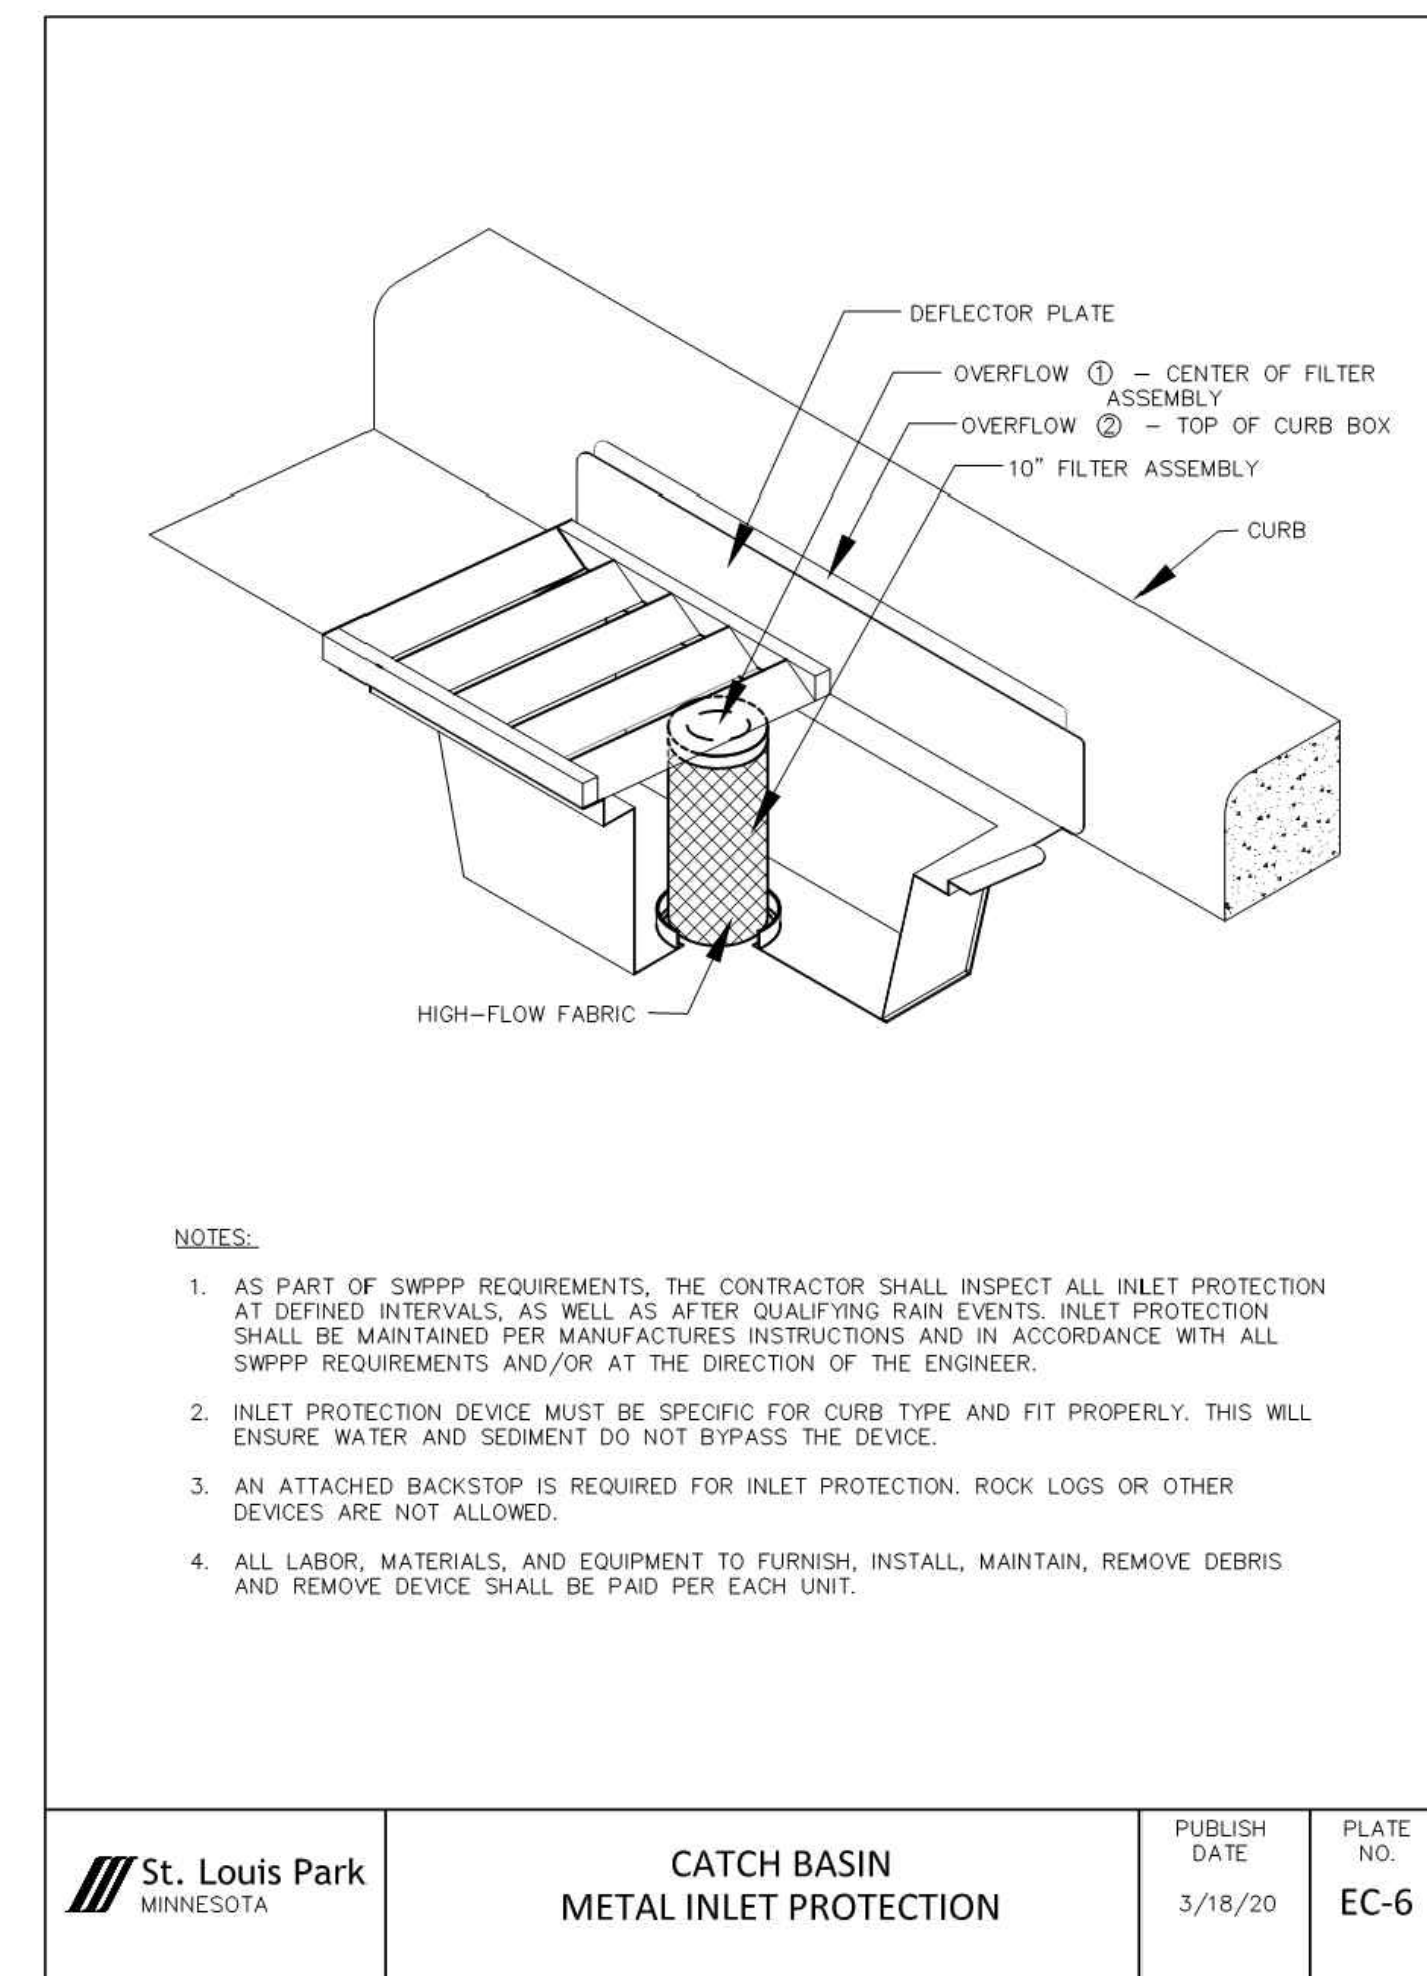

4 CONSTRUCTION ENTRANCE  
 CO.10 SCALE: NOT TO SCALE

NOT FOR  
 CONSTRUCTION

PUD APPLICATION  
 -  
 SEP 07 2021

ORIGINAL ISSUE:  
 REVISIONS:  
 No. Description Date

018843-000  
 WSB PROJECT NUMBER  
 PJM CLB  
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 DETAILS

9920 Wayzata Blvd

TITLE  
**CO.10**





**UTILITY PLAN DETAIL NOTES**

- CONTRACTOR SHALL INSTALL THE SANITARY SEWER MANHOLES & SERVICES PER CITY DETAILS. (SEE DETAILS 1, 2, 3, & 4/C0.14)
- CONTRACTOR SHALL DISCONNECT EXISTING SANITARY SERVICES PER CITY DETAIL. (SEE DETAIL 5/C0.14)
- CONTRACTOR SHALL RECONSTRUCT THE EXISTING SANITARY SEWER MANHOLE PER CITY DETAIL. (SEE DETAIL 4/C0.14)
- CONTRACTOR SHALL INSTALL THE WATERMAIN, HYDRANT, GATE VALVES, FITTINGS, INSULATION & WATER SERVICES PER CITY DETAILS. (SEE DETAIL 6, 7, 8/C0.14 & 1/C0.15)
- CONTRACTOR SHALL INSTALL THE TAPPING SLEEVE AND VALVE PER CITY DETAIL. (SEE DETAIL 2/C0.16)
- CONTRACTOR SHALL INSTALL THE THRUST BLOCKING PER CITY DETAIL. (SEE DETAIL 4/C0.16)
- CONTRACTOR SHALL DISCONNECT EXISTING WATER SERVICES PER CITY DETAIL. (SEE DETAIL 2/C0.15)
- CONTRACTOR SHALL INSTALL THE STORM SEWER STRUCTURES PER CITY DETAILS. (SEE DETAILS 3, 4, 5 & 6/C0.15, 2/C0.15, 3/C0.15, 4/C0.15)
- R-TANK UNDERGROUND STORAGE SYSTEM. (SEE DETAIL SHEET C0.13)
- PIPE BEDDING SEE DETAILS. (1/C0.16 & 2/C0.16)
- REFER TO SHEET C0.07 FOR PROPOSED AND EXISTING GRADES

**UTILITY NOTES**

- ALL UTILITIES WILL BE CONSTRUCTED PER CURRENT CITY OF ST. LOUIS PARK SPECIFICATIONS.
- CONTRACTOR SHALL REFER TO MECHANICAL FOR CONTINUATION OF UTILITY SERVICES. ALL SERVICES SHALL BE VERIFIED PRIOR TO CONSTRUCTION
- THE CONTRACTOR IS RESPONSIBLE FOR COORDINATING DESIGN AND INSTALLATION OF PRIVATE UTILITIES WITH THE PRIVATE UTILITY COMPANIES (NATURAL GAS, ELECTRIC, CABLE TV, FIBER, ETC).
- COORDINATE INSPECTION AND TESTING FOR ALL UNDERGROUND UTILITIES WITH THE APPROPRIATE AUTHORITIES PRIOR TO COVERING TRENCHES. COMPLY WITH ALL LOCAL REQUIREMENTS. CONDUCT ALL TESTS TO THE SATISFACTION OF THE LOCAL AUTHORITIES.
- COORDINATES ARE TO END OF PIPE, CENTER OF APPURTENANCE, OR CENTER OF STRUCTURE UNLESS OTHERWISE NOTED.
- ALL UTILITIES AND CONDUITS SHALL TERMINATE 5' OUTSIDE THE FACE OF THE BUILDING UNLESS OTHERWISE NOTED.
- ALL EXISTING UTILITIES AND SERVICE LINES SHALL BE KEPT IN SERVICE AT ALL TIMES DURING CONSTRUCTION OF THIS PROJECT, UNLESS OTHERWISE AUTHORIZED BY THE CITY OF ST. LOUIS PARK.
- REPORT ANY DISCREPANCIES TO THE ENGINEER. RECONNECT ALL SERVICES NOT MARKED FOR REMOVAL OR AS DIRECTED BY THE OWNER.
- INSTALL ALL WATER MAINS AND APPURTENANCES IN ACCORDANCE WITH CITY OF ST. LOUIS PARK STANDARDS, AWWA AMERICAN WATERWORKS ASSOCIATION, MINNESOTA DNR AND THE NATIONAL FIRE PREVENTION ASSOCIATION (NFA) STANDARDS.
- PROVIDE ANY ADDITIONAL BENDS WITH THRUST BLOCKS AND OTHER APPURTENANCES REQUIRED TO ASSURE PROPER INSTALLATION OF WATER MAINS AND LATERALS. PROVIDE A VERTICAL TIE-DOWN BLOCK FOR ANY VERTICAL BEND DOWN AND PROVIDE A CRADLE FOR ANY VERTICAL BEND UP. PROVIDE MECHANICAL DIP JOINT BENDS AS NEEDED.
- MINIMUM 18" VERTICAL DISTANCE BETWEEN PIPE CROSSINGS. IN THE EVENT OF A CONFLICT BETWEEN WATER LINES AND STORM OR SANITARY SEWER PIPING, ADJUST THE WATER LINE DOWNWARDS IN SUCH A MANNER SO THAT THE PIPE MANUFACTURER'S RECOMMENDATIONS ON PIPE DEFLECTION AND JOINT STRESS ARE NOT EXCEEDED.
- CONDUCT A PRESSURE TEST ON ALL WATER MAIN, SANITARY FORCEMAIN AND FIRE PROTECTION LINES TO THE SATISFACTION OF THE LOCAL APPROVAL AUTHORITY AND THE OWNER'S INSURANCE CARRIER.
- PROVIDE ALL WATER AND FIRE LINES WITH A MINIMUM DEPTH OF COVER OF 7.5 FEET.
- HYDRANTS PLACED WHERE THE GROUNDWATER TABLE IS ABOVE THE DRAIN HOLE OUTLET SHALL HAVE THE DRAIN HOLE PLUGGED AND BE EQUIPPED WITH A TAG STATING THE NEED FOR PUMPING AFTER USE.
- ALL POTABLE WATER PIPES, FITTINGS AND FIXTURES SHALL MEET THE 'REDUCTION OF LEAD IN DRINKING WATER ACT' WHICH ESTABLISHES A MAXIMUM LEAD CONTENT OF 0.25 PERCENT BY WEIGHTED AVERAGE OF THE WETTED SURFACES. HYDRANTS AND WATER DISTRIBUTION GATE VALVES 2 INCHES IN DIAMETER OR GREATER ARE EXEMPT.
- THE CONTRACTOR SHALL ADJUST TO GRADE ALL WATER AND GAS VALVE BOXES AND MANHOLES THAT FALL WITHIN THE LIMITS OF THIS CONTRACT. THE CONTRACTOR SHALL KEEP ALL SAID WATER, GAS AND EXISTING SEWERS AND THEIR APPURTENANCES FREE OF DEBRIS AND OPERABLE AT ALL TIMES DURING CONSTRUCTION.
- A #11 AWG TRACER WIRE SHALL BE INSTALLED ON ALL NON-METALLIC PIPES, THE WIRE SHALL BE TAPED TO THE PIPE EVERY 20 FEET, AND SHALL BE CONTINUOUS AND ACCESSIBLE ABOVEGROUND AT ALL VALVES AND BUILDING RISERS.
- 10-FOOT HORIZONTAL SEPARATION REQUIRED BETWEEN SEWER LINES AND/OR STRUCTURES AND POTABLE WATER LINES. 18-INCH VERTICAL SEPARATION IS REQUIRED AT ALL WATERMAIN CROSSINGS OF STORM OR SANITARY SEWER.
- CONTRACTOR SHALL IDENTIFY, FIELD VERIFY AND COORDINATE ALL EXISTING AND PROPOSED UTILITY CROSSINGS IN THE FIELD. REPORT CONFLICTS REQUIRING REDESIGN TO THE ENGINEER OF RECORD.

**LEGEND**

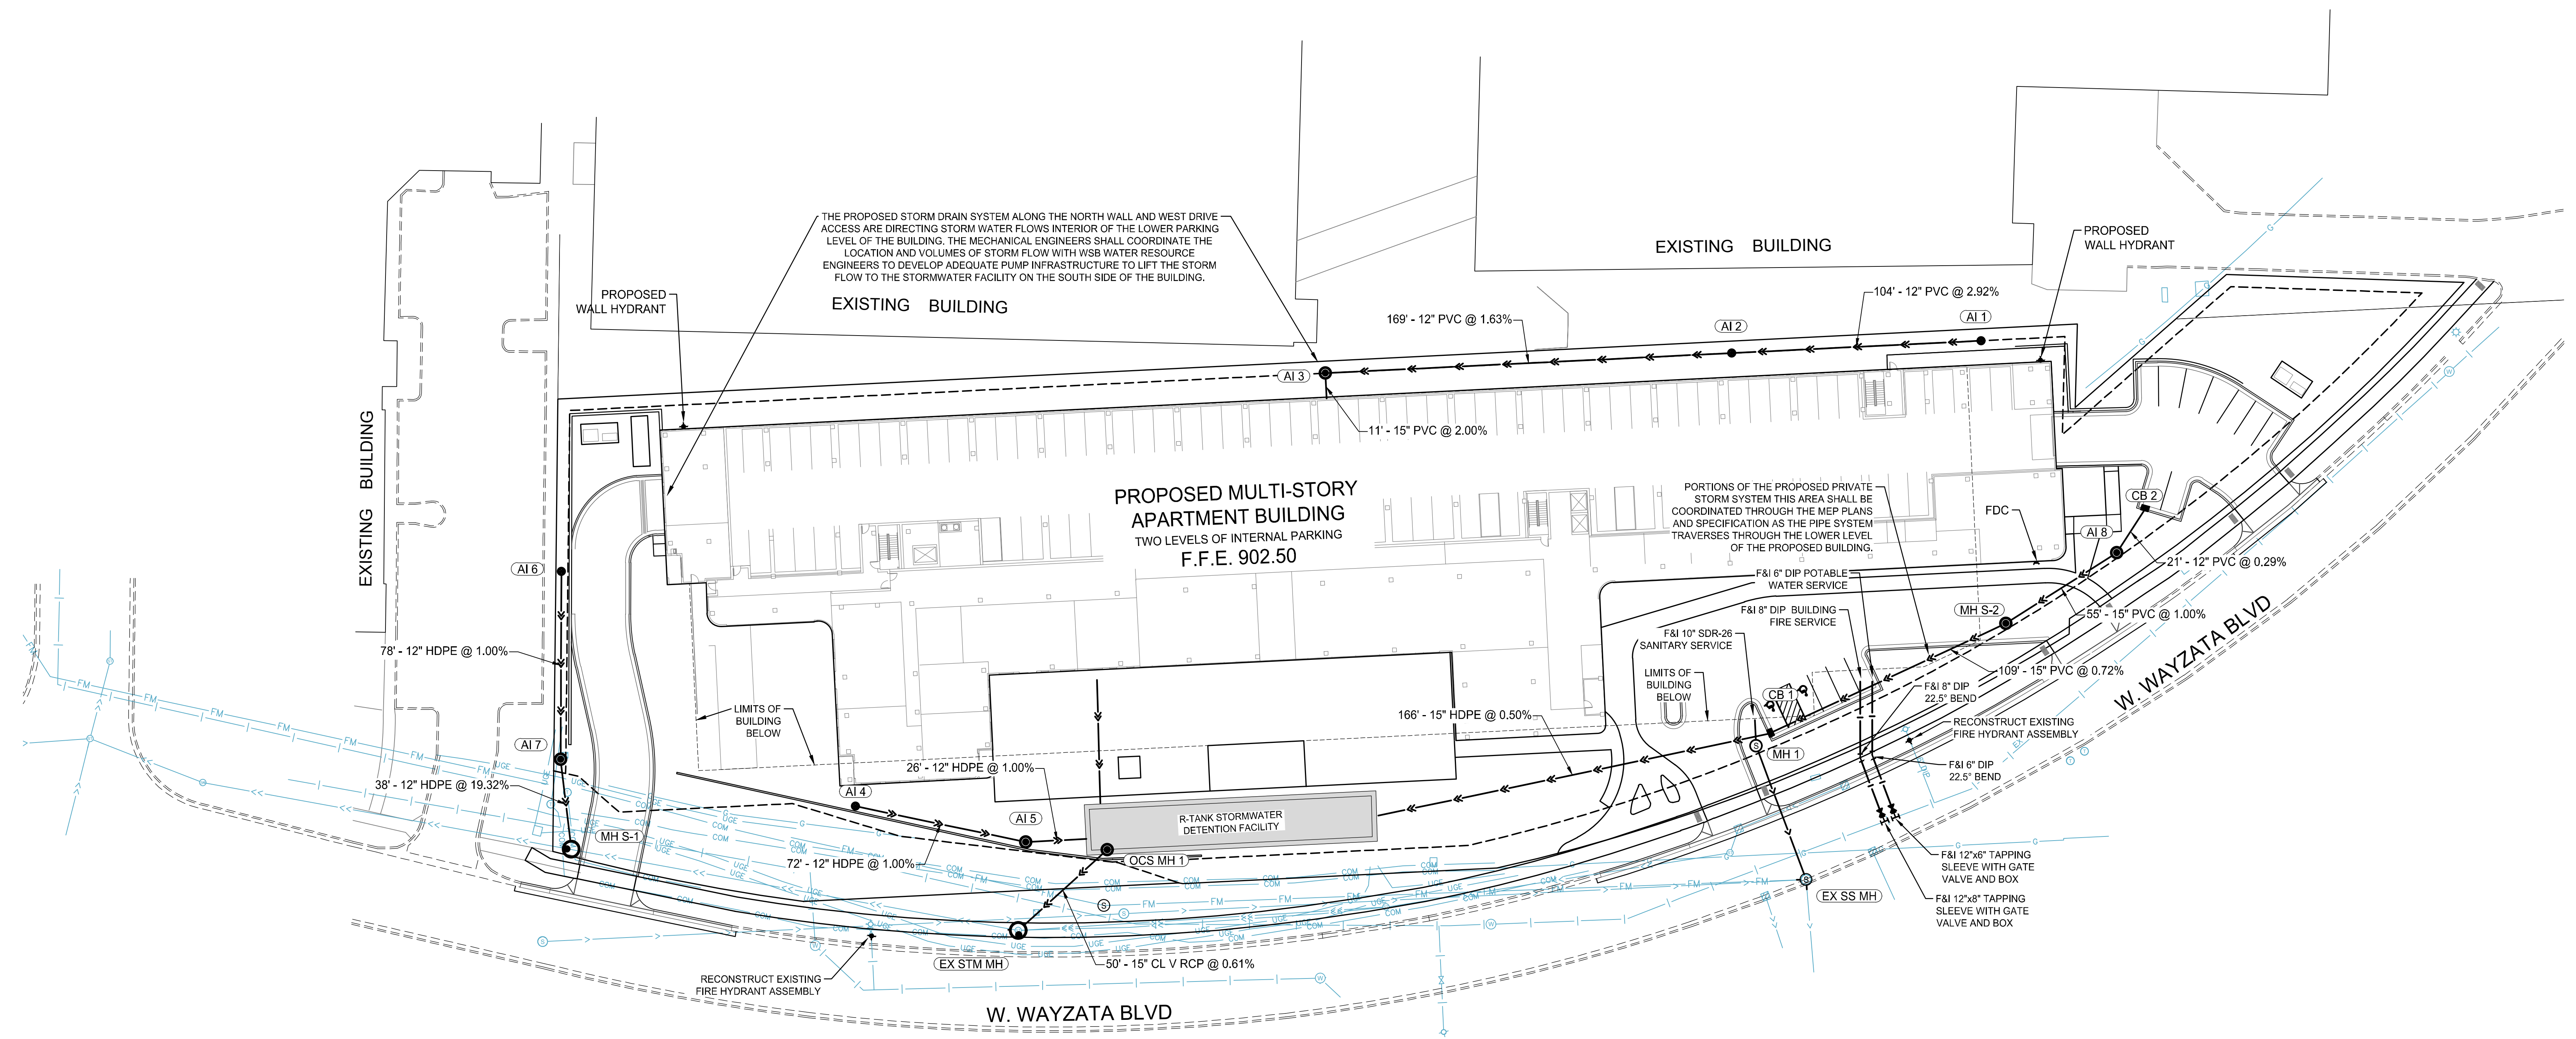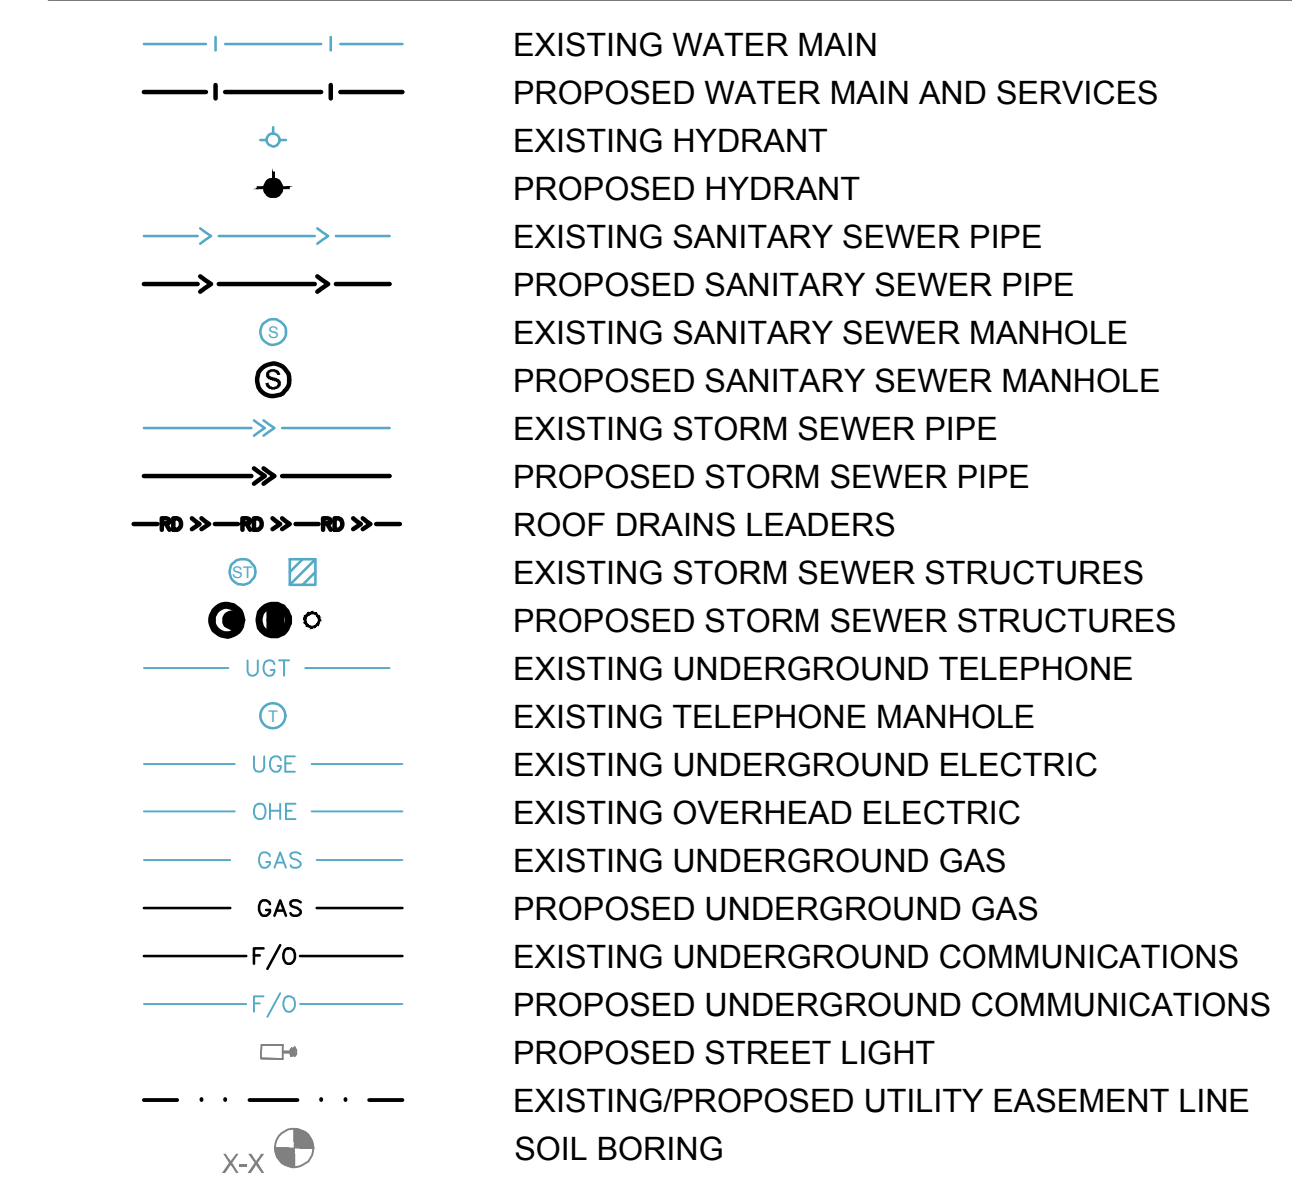

**NOT FOR CONSTRUCTION**

PUD APPLICATION  
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**UTILITY PLAN**

9920 Wayzata Blvd

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